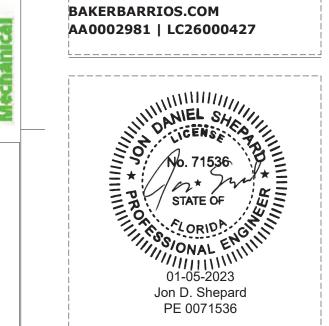
PLUMBING NOTES 1. PROVIDE SLEEVE OR RELIEF ARCH FOR PIPING PASSING THROUGH OR BELOW THE BUILDING.

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MILHAUS

SR-82

7780 LIGHTARD KNOTT LN FORT MYERS, FL 33905


220035.00

SANITARY PLAN -UNDERGROUND

RP1.00


SANITARY PLAN - UNDERGROUND
1/8" = 1'-0"

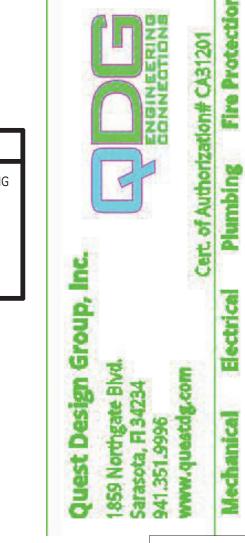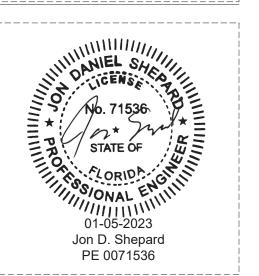1. PROVIDE SLEEVE OR RELIEF ARCH FOR PIPING PASSING THROUGH OR BELOW THE BUILDING.





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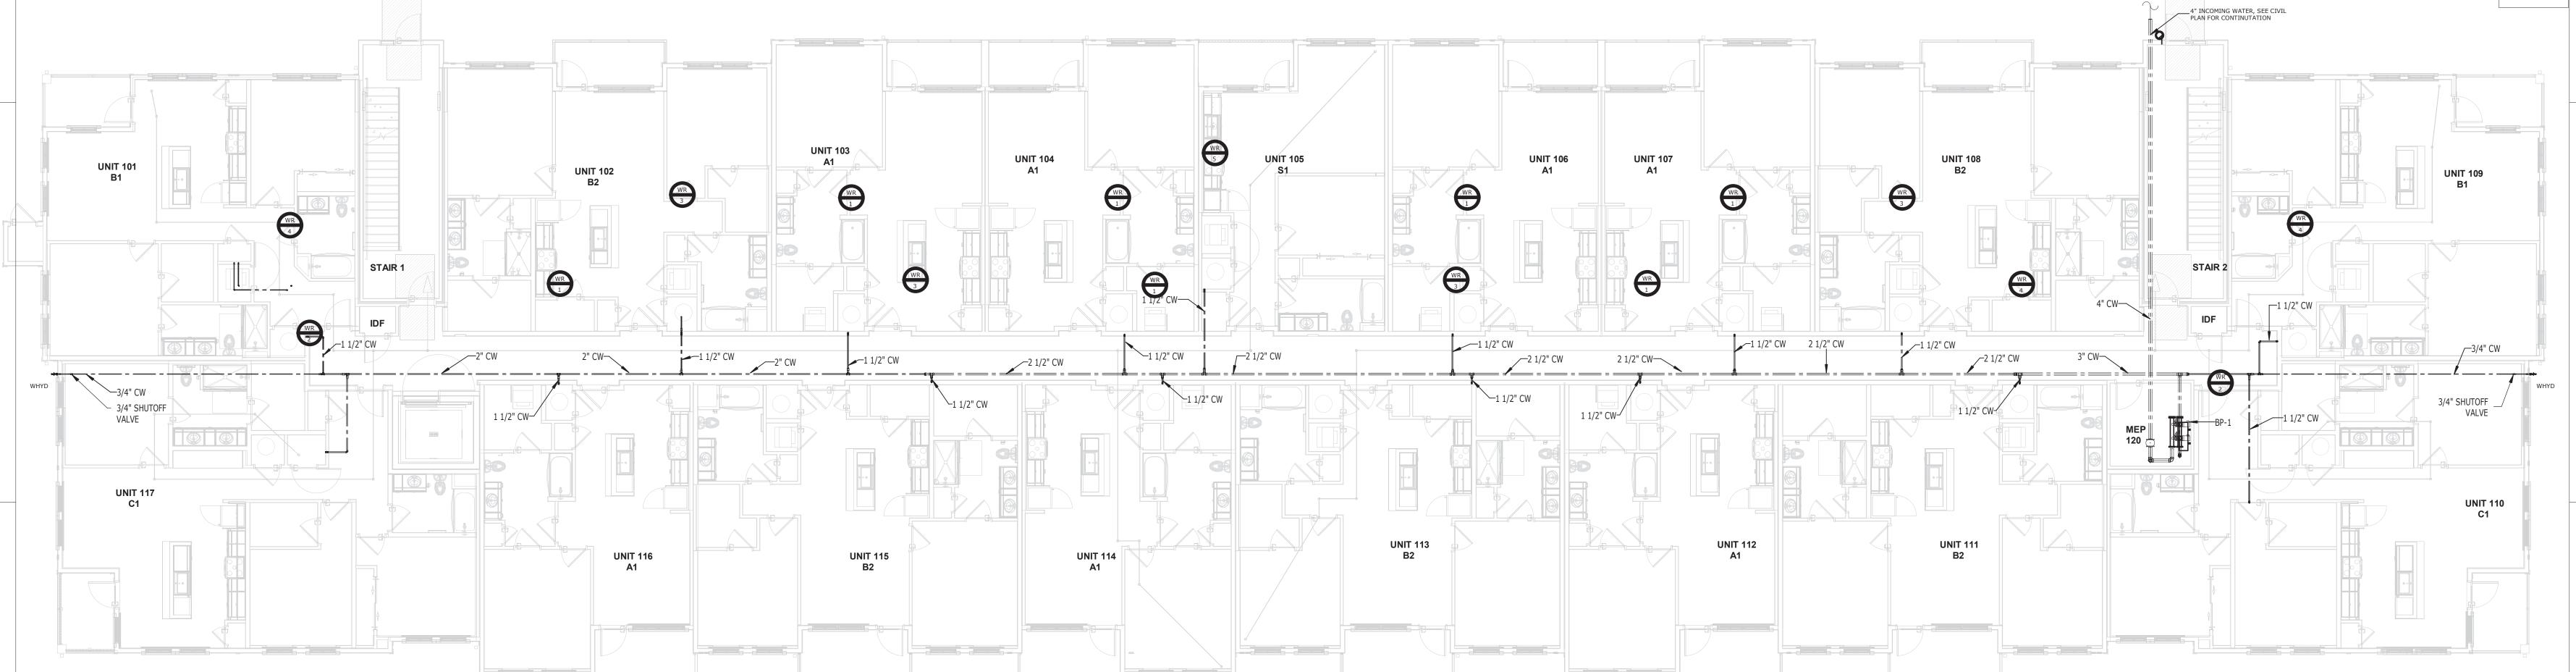
SR-82

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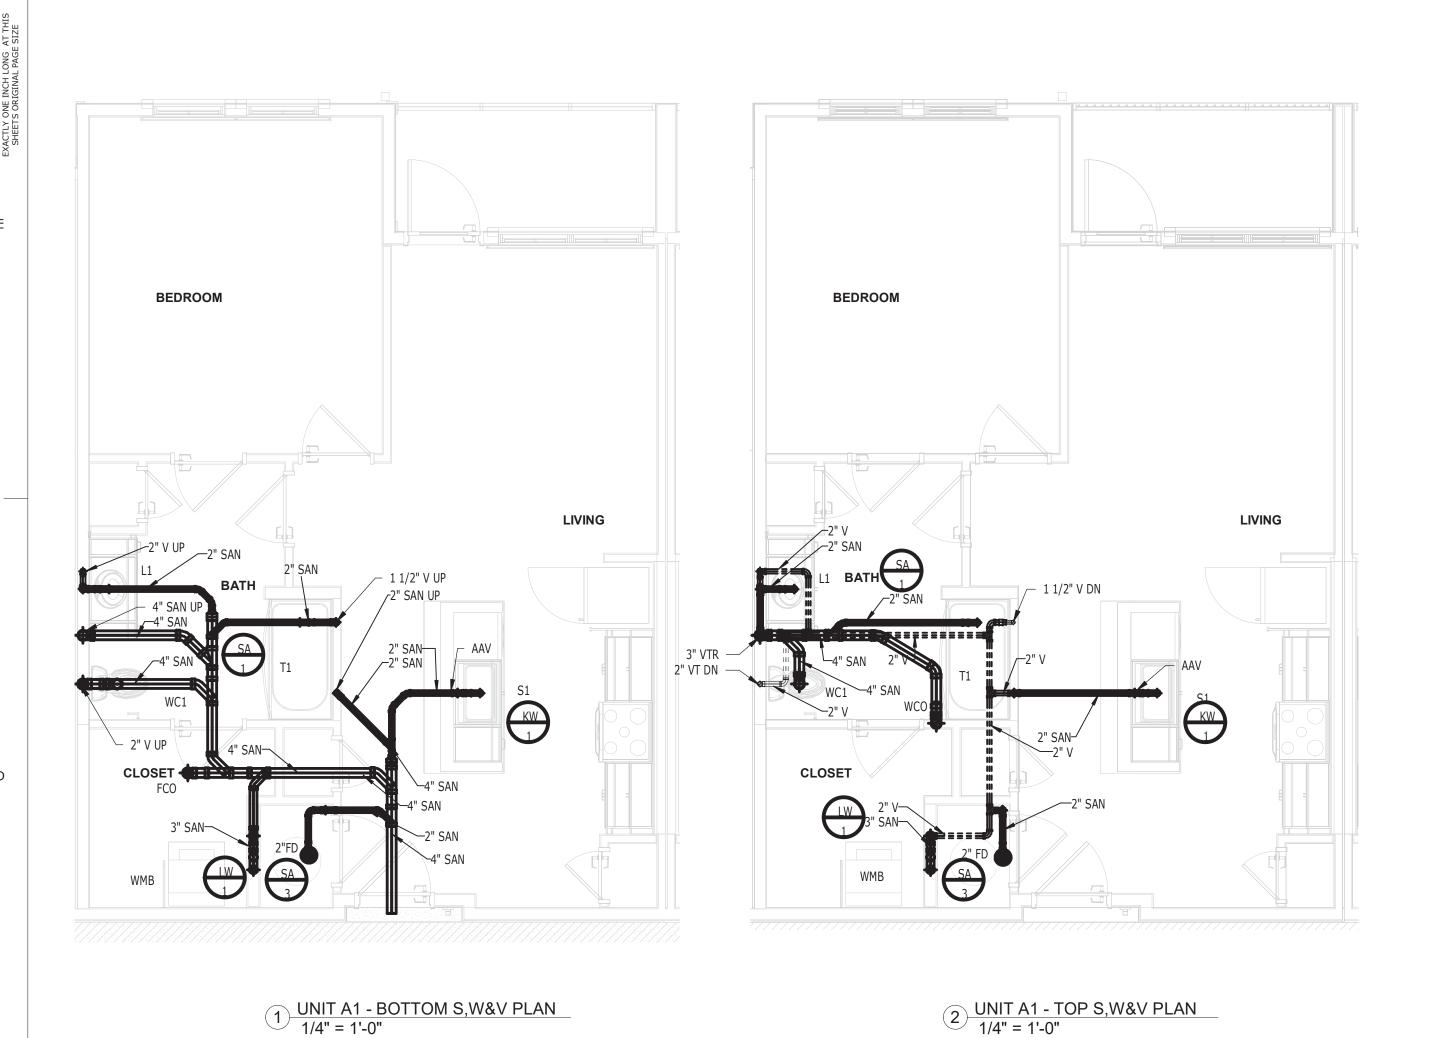
220035.00


DOMESTIC WATER PLAN - FIRST FLOOR

SHEET NUMBER: RP2.00




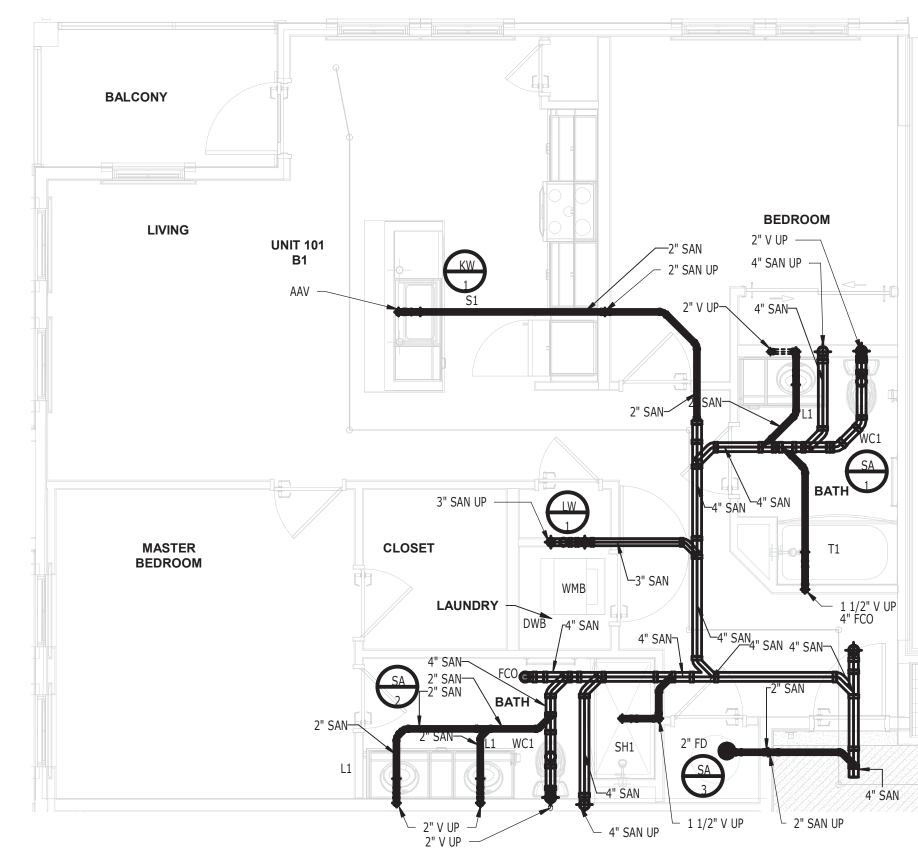1) DOMESTIC WATER PLAN - FIRST FLOOR 1/8" = 1'-0"





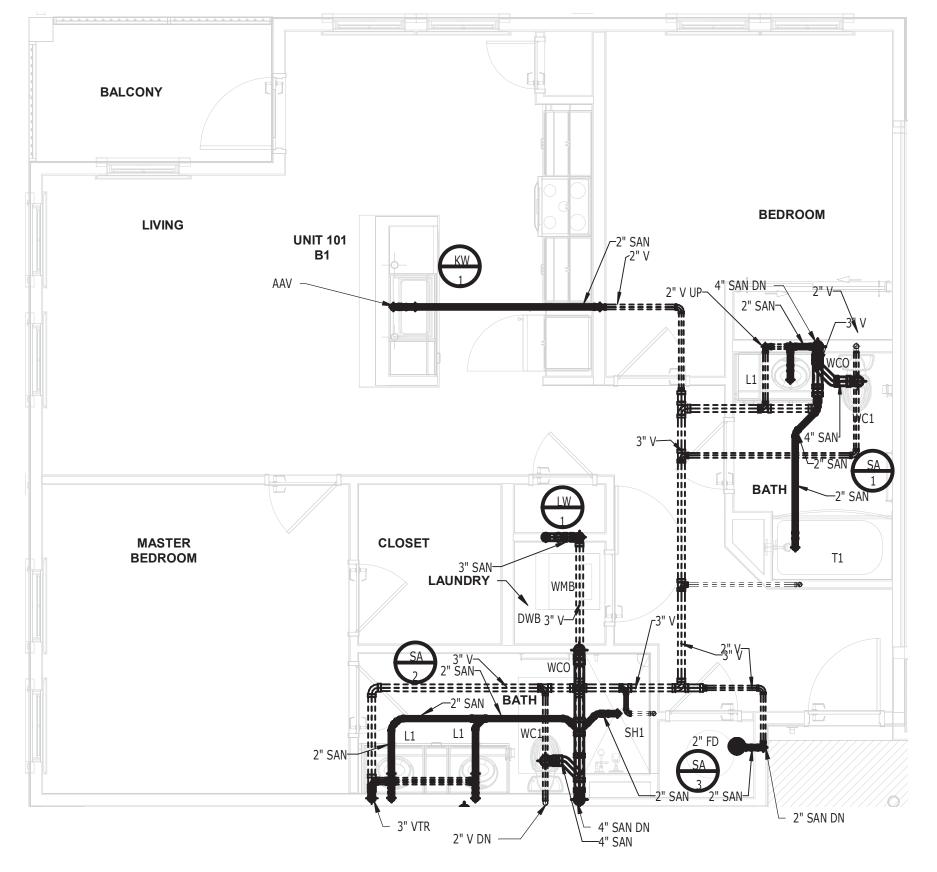5 <u>UNIT B1 - BOTTOM S,W&V PLAN</u> 1/4" = 1'-0"



6 UNIT B1 - TOP S,W&V PLAN 1/4" = 1'-0"

8 UNIT B1 - DOMESTIC WATER PLAN
1/4" = 1'-0"

— 1" HW DN BEDROOM

3/4" CW DN—√ 3/4" HW DN─\

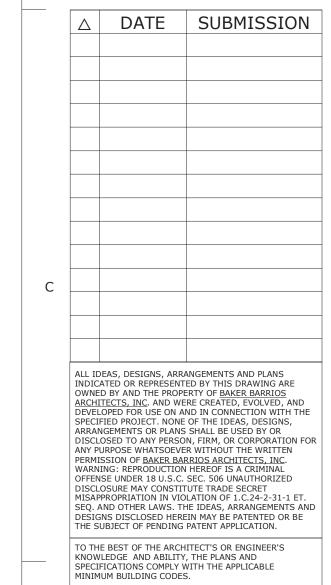
BALCONY

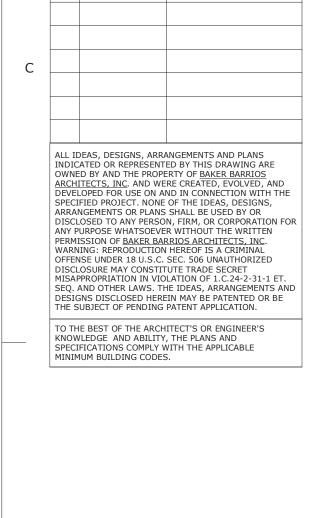
MASTER BEDROOM WATER SERVICE TO BE

DROPPED TO BELOW FLOOR —



NOT FOR CONSTRUCTION








SR-82

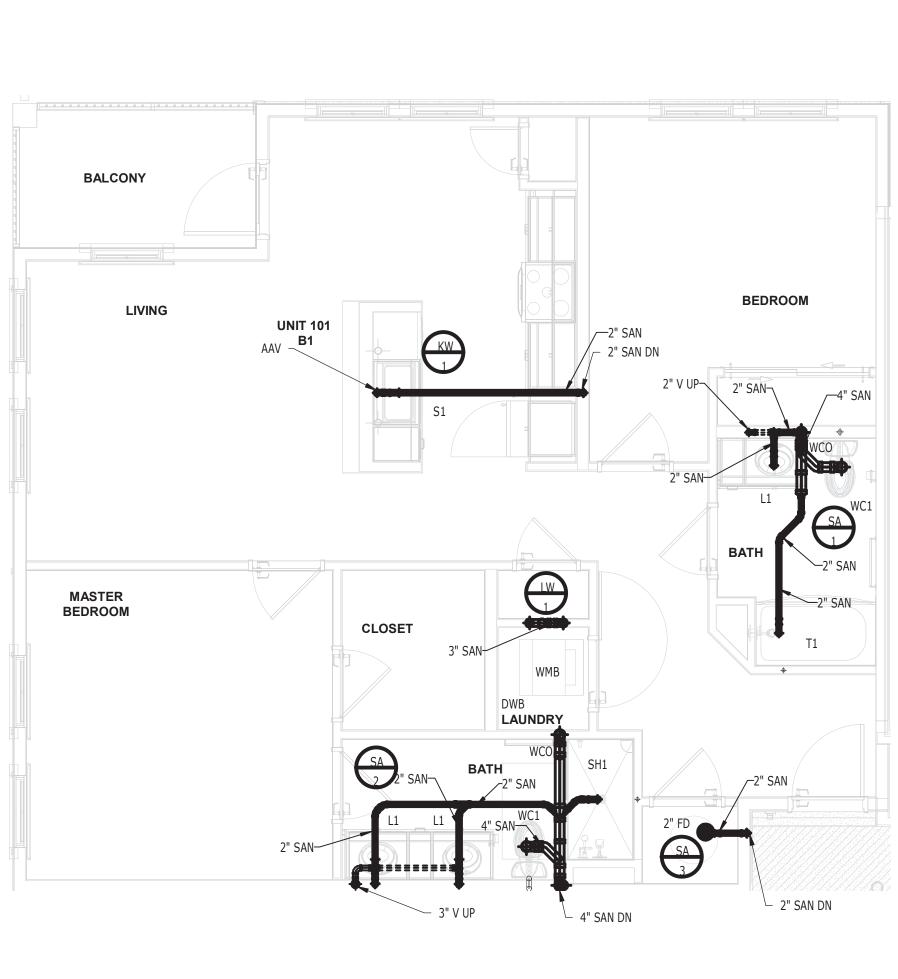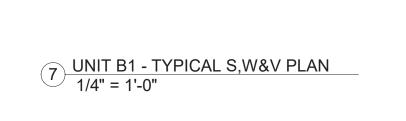
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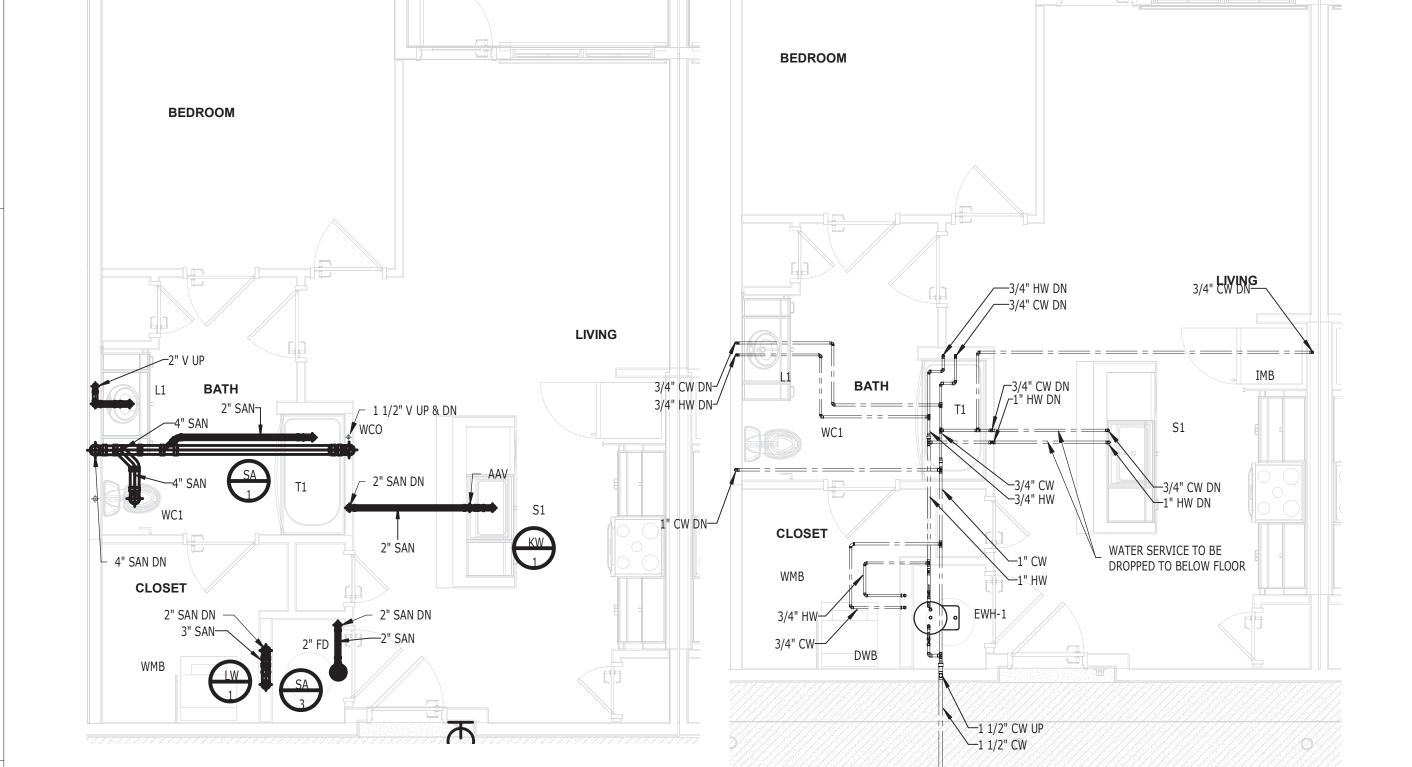
220035.00

SANITARY & DOMESTIC WATER UNIT PLANS

SHEET NUMBER: RP3.00







UNIT A1 - DOMESTIC WATER PLAN
1/4" = 1'-0"

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BEDROOM

UNIT 102 B1

1 UNIT B2 - BOTTOM S,W&V PLAN 1/4" = 1'-0"

MASTER BEDROOM

CLOSET

_4" SAN **BATH**

2" KW TO ABOVE FLOOR

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BALCONY

LAUNDRY


Baker Barrios ORLANDO

BEDROOM

3" VTR

7 UNIT S1 - TOP S,W&V PLAN
1/4" = 1'-0"

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MILHAUS ®

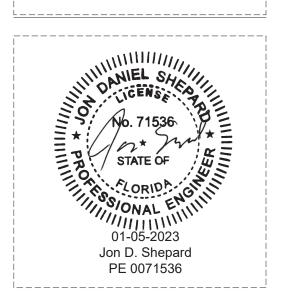
MILHAUS


SR-82

7780 LIGHTARD KNOTT LN FORT MYERS, FL 33905 220035.00


SANITARY & DOMESTIC WATER UNIT PLANS

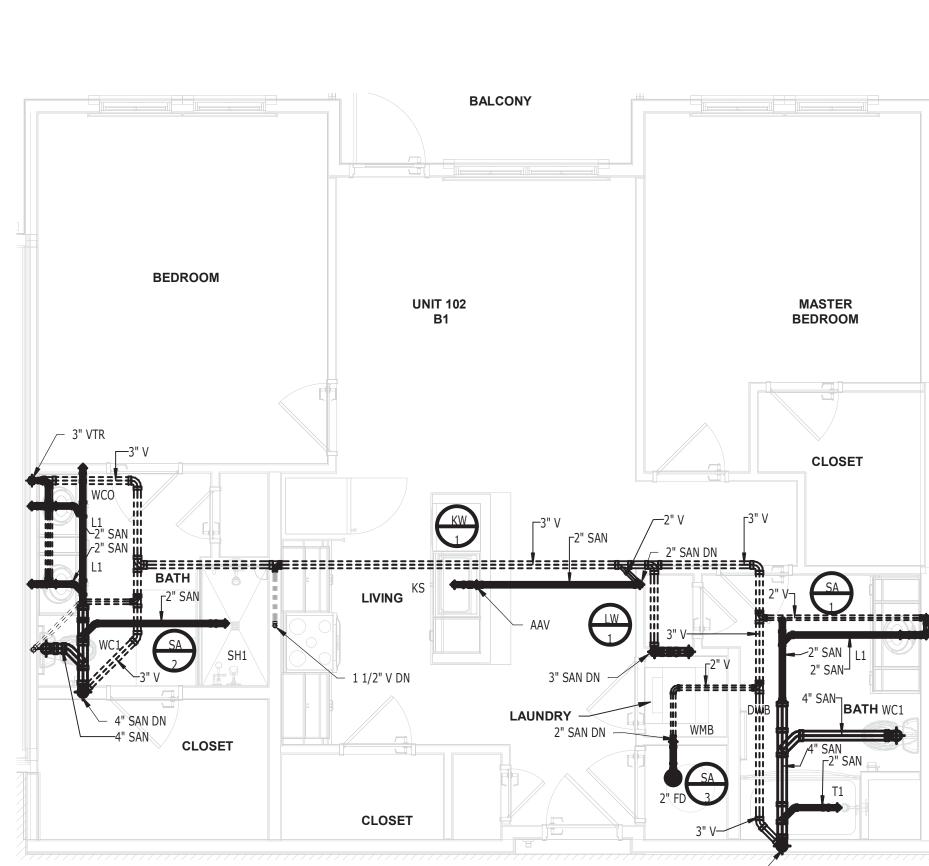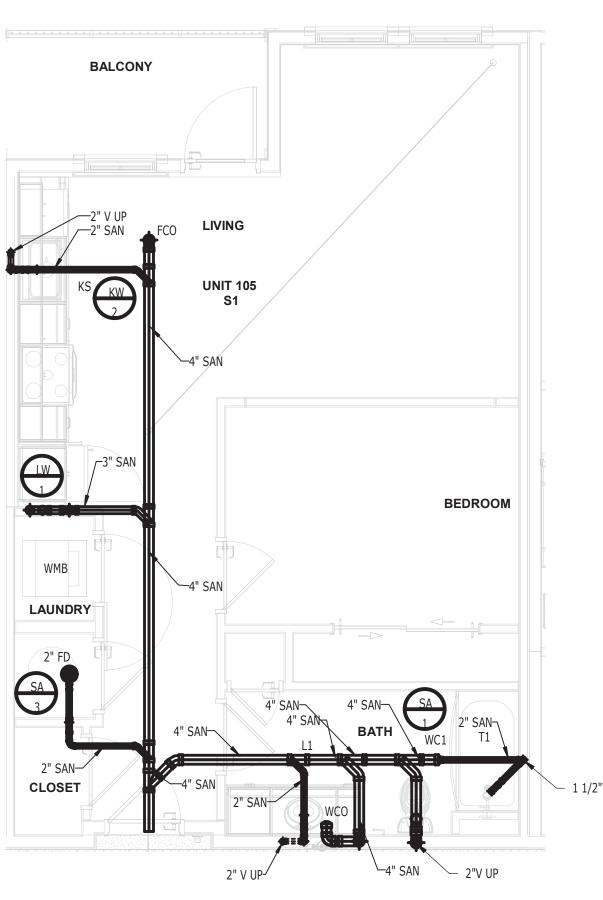
SHEET NUMBER: RP3.01







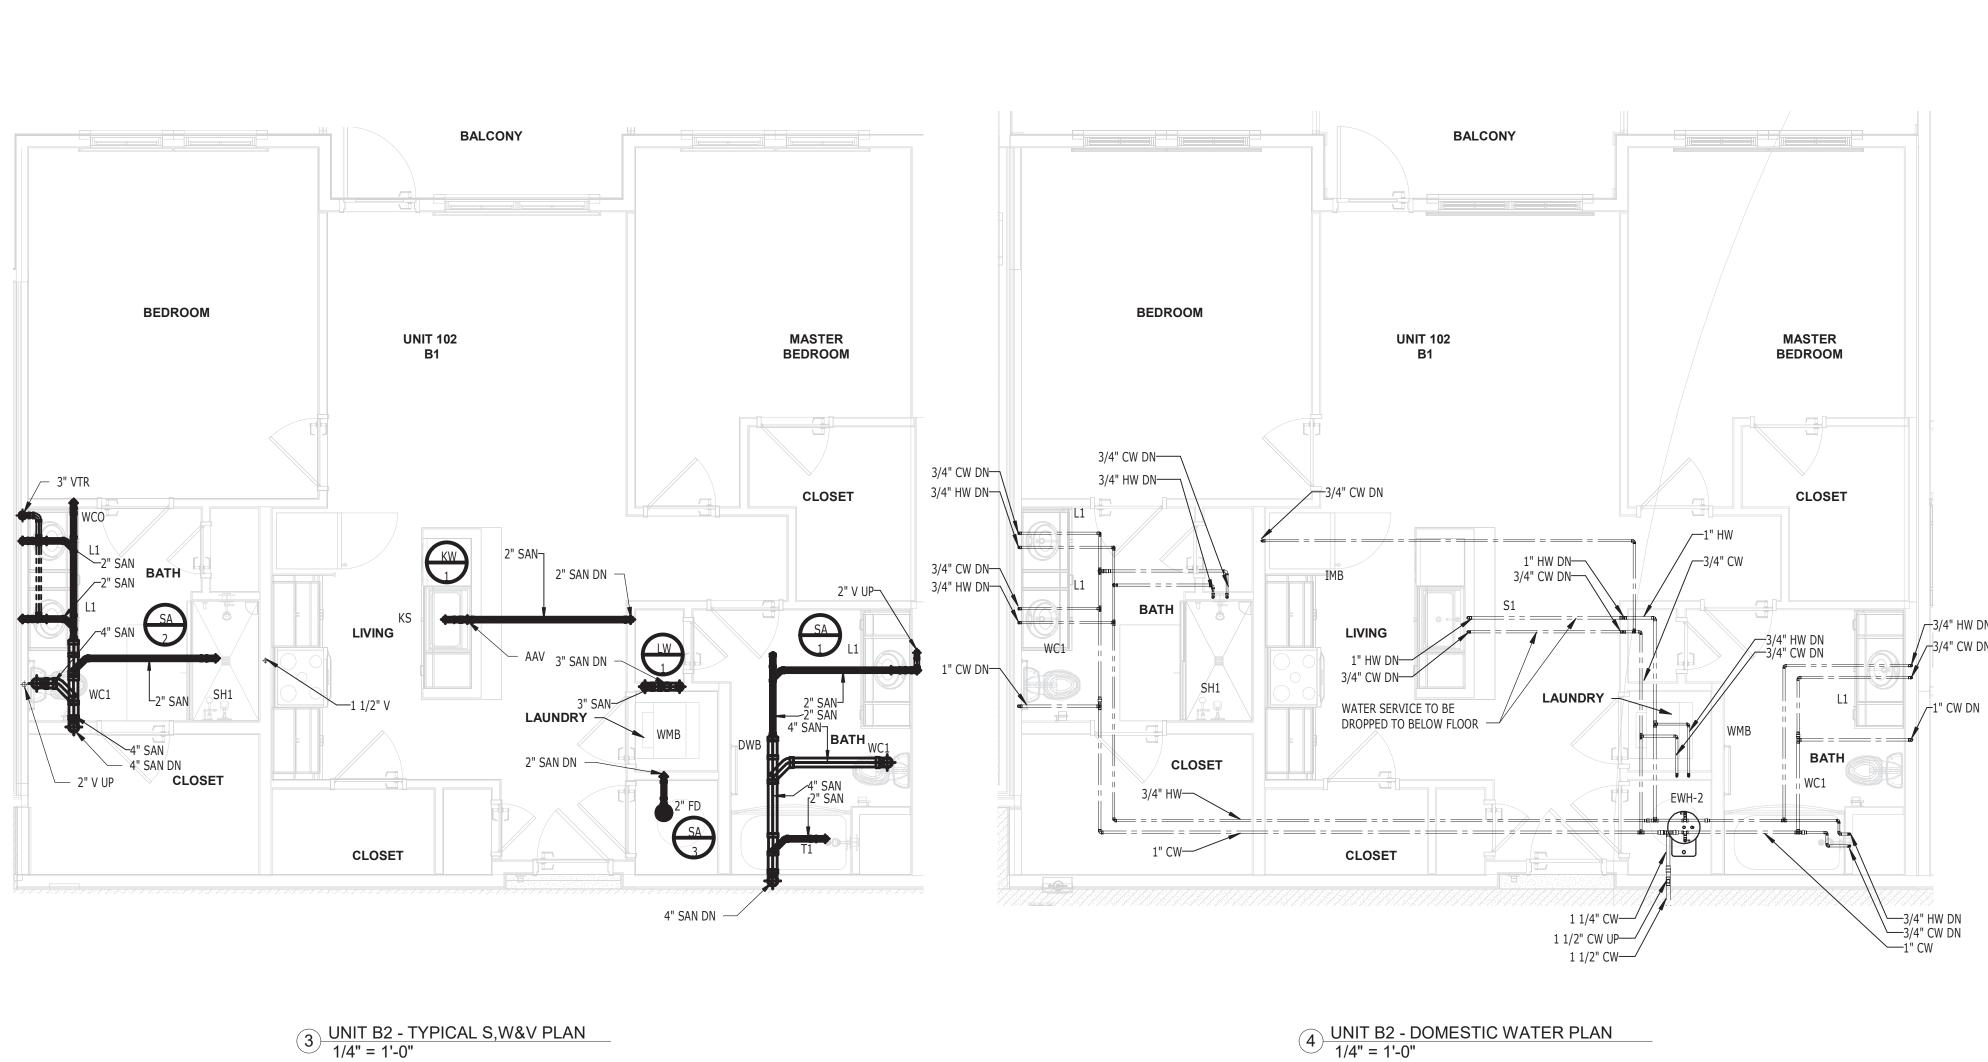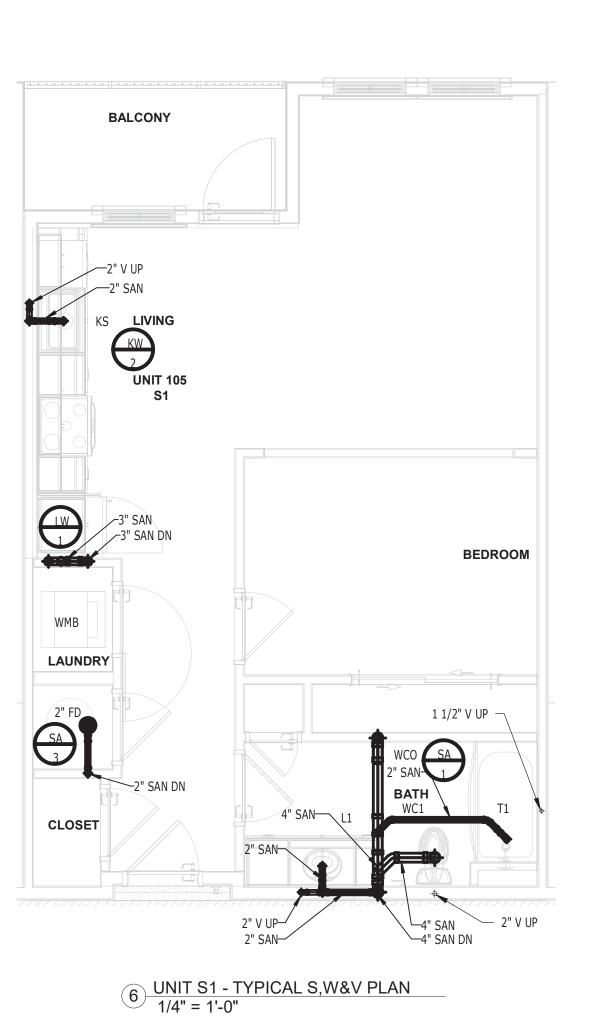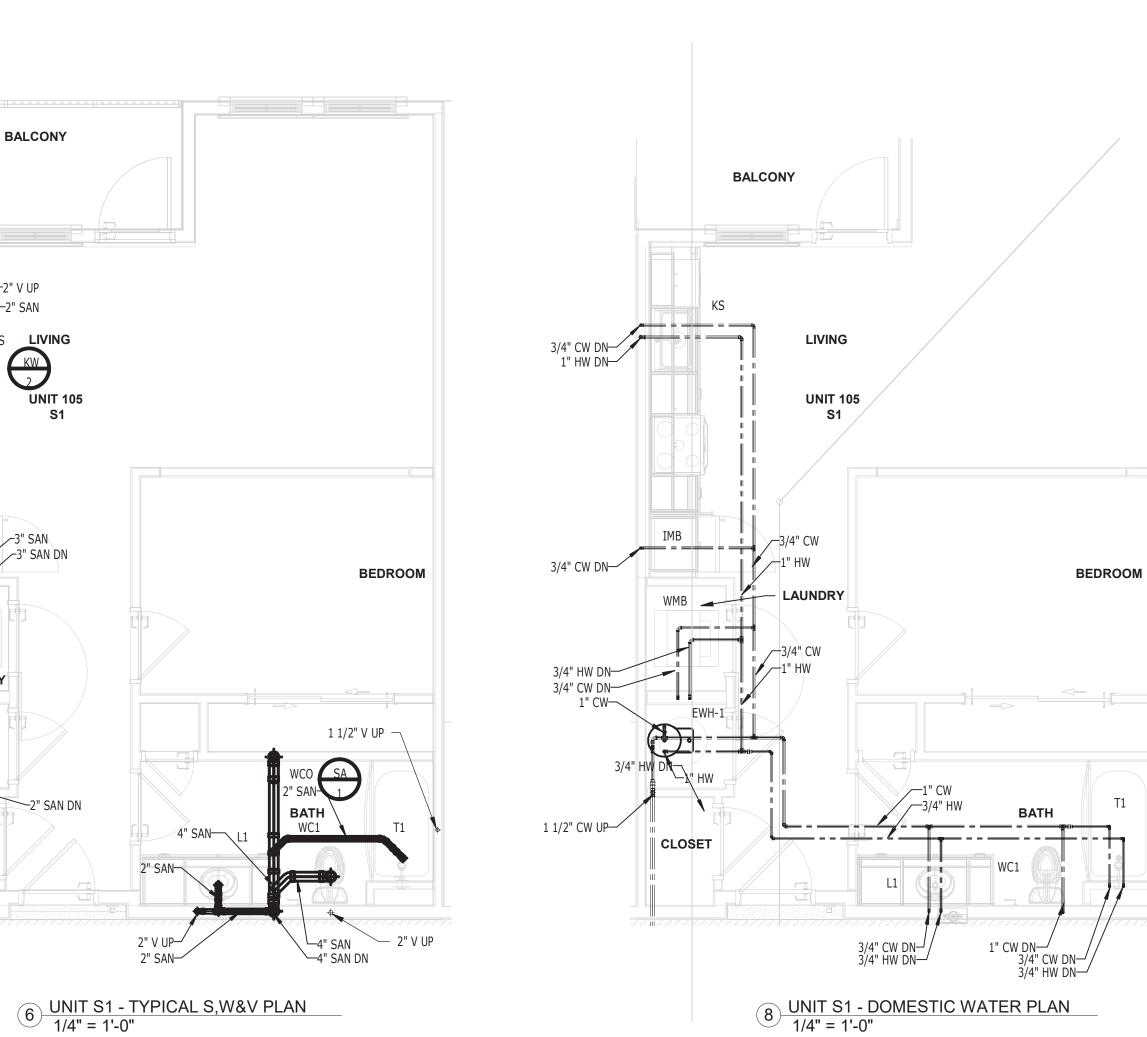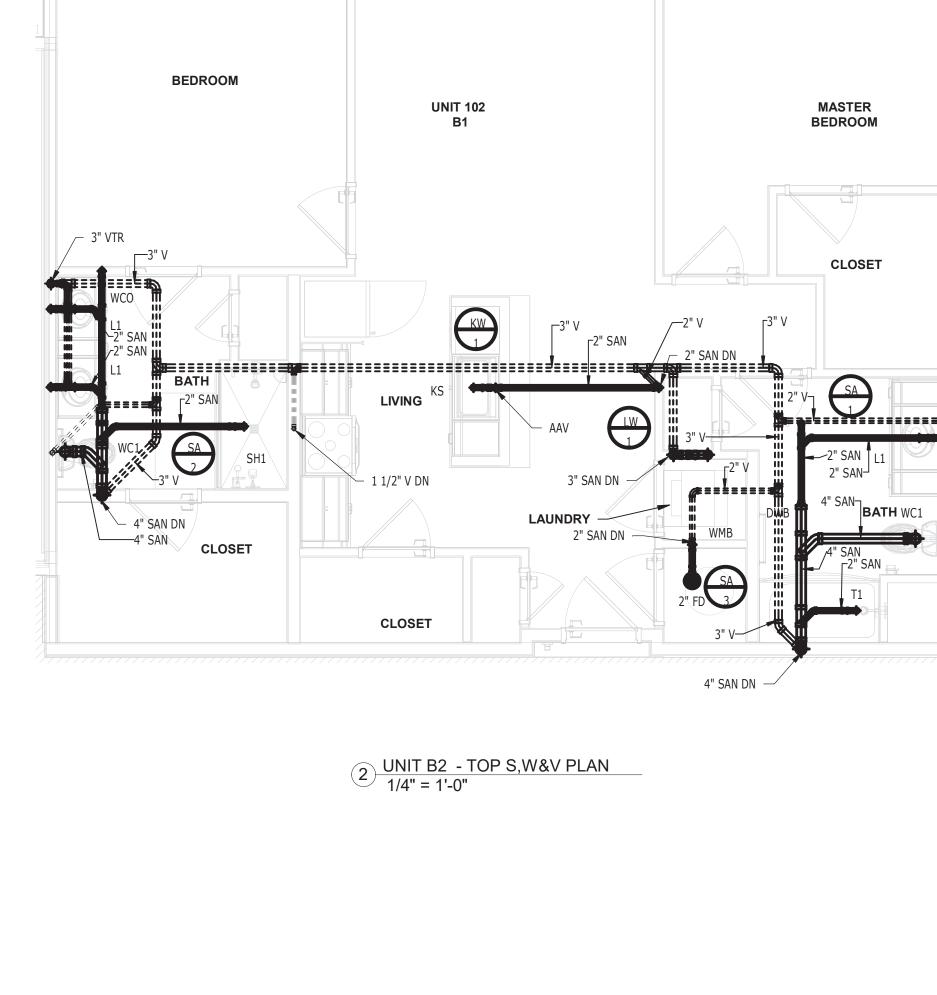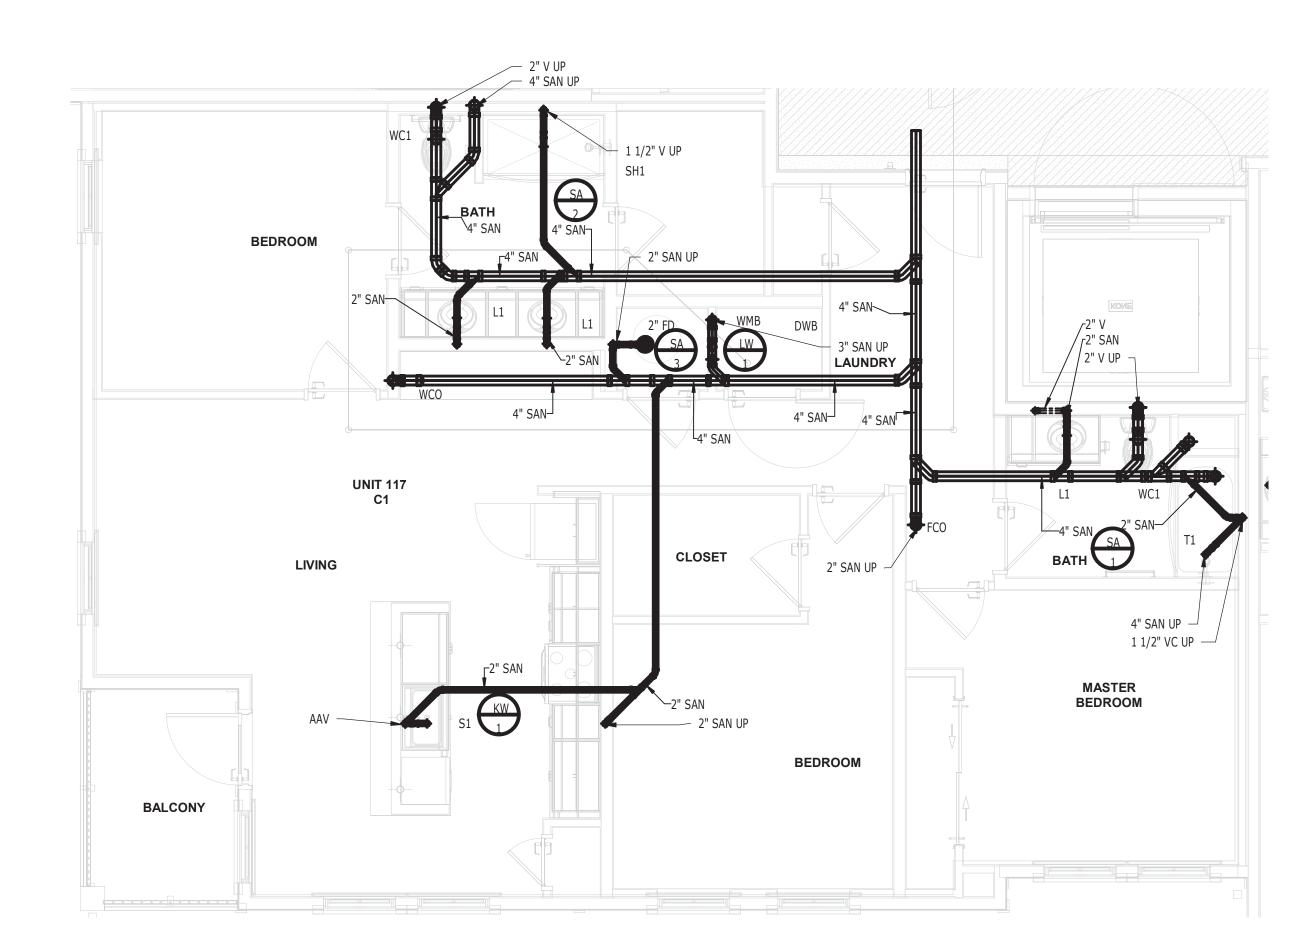
5 UNIT S1 - BOTTOM S,W&V PLAN 1/4" = 1'-0"













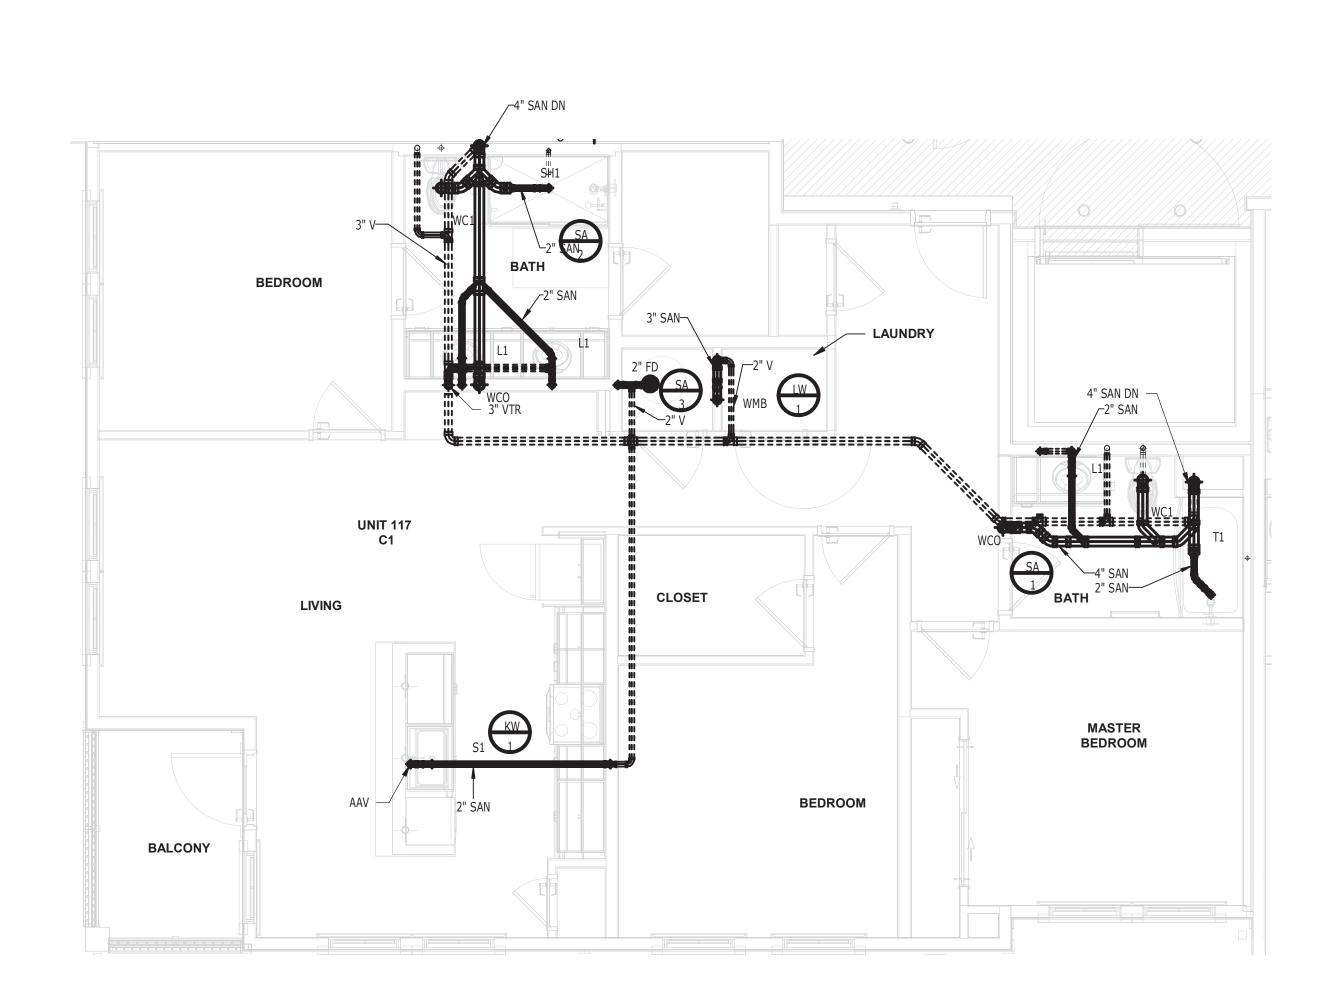
1 UNIT C1 - BOTTOM S,W&V PLAN 1/4" = 1'-0"



3 UNIT C1 - TOP S,W&V PLAN 1/4" = 1'-0"

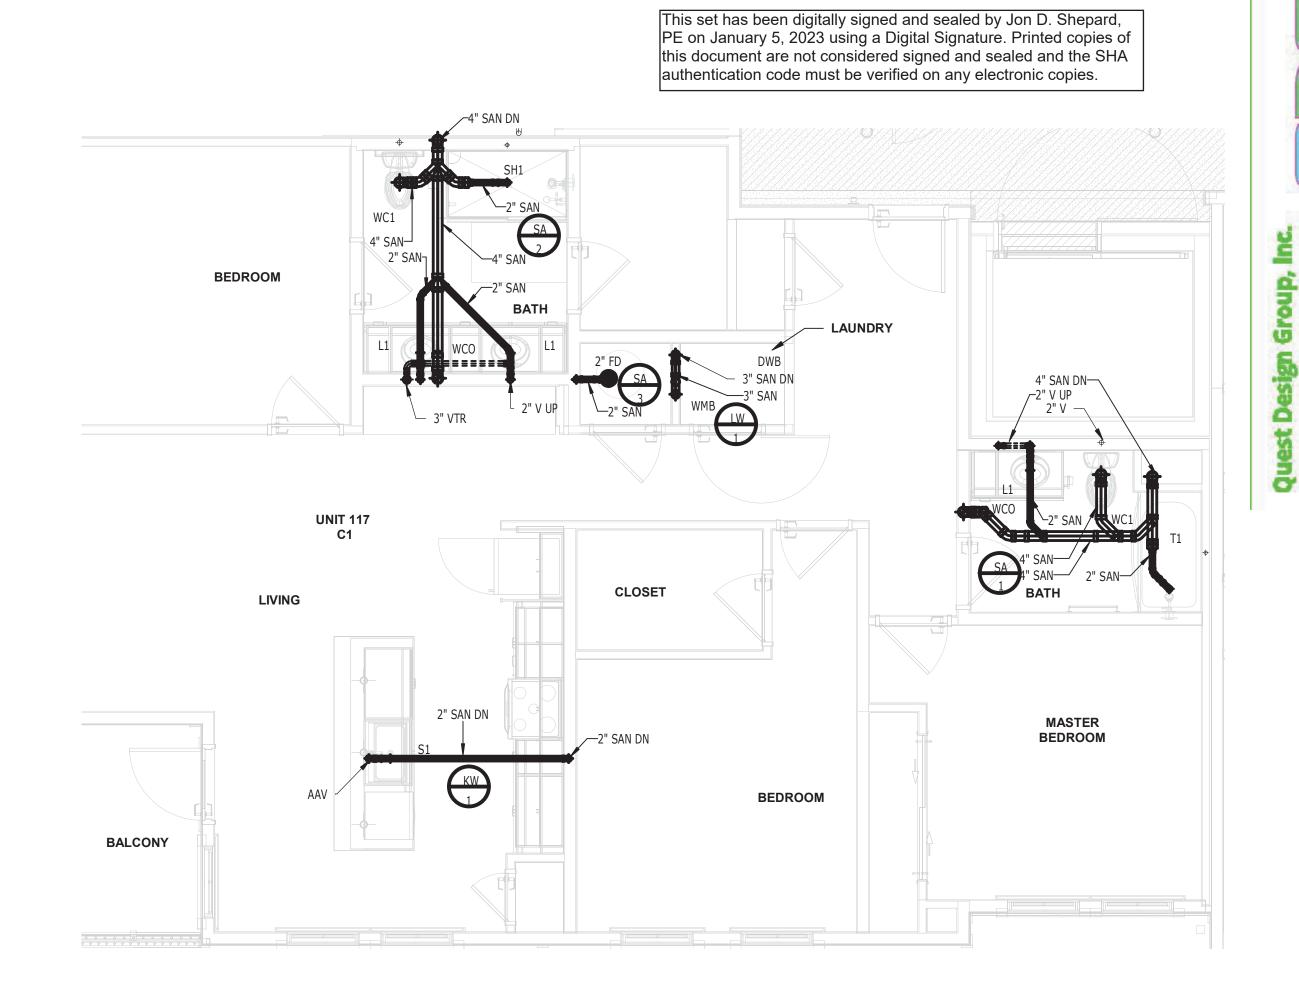

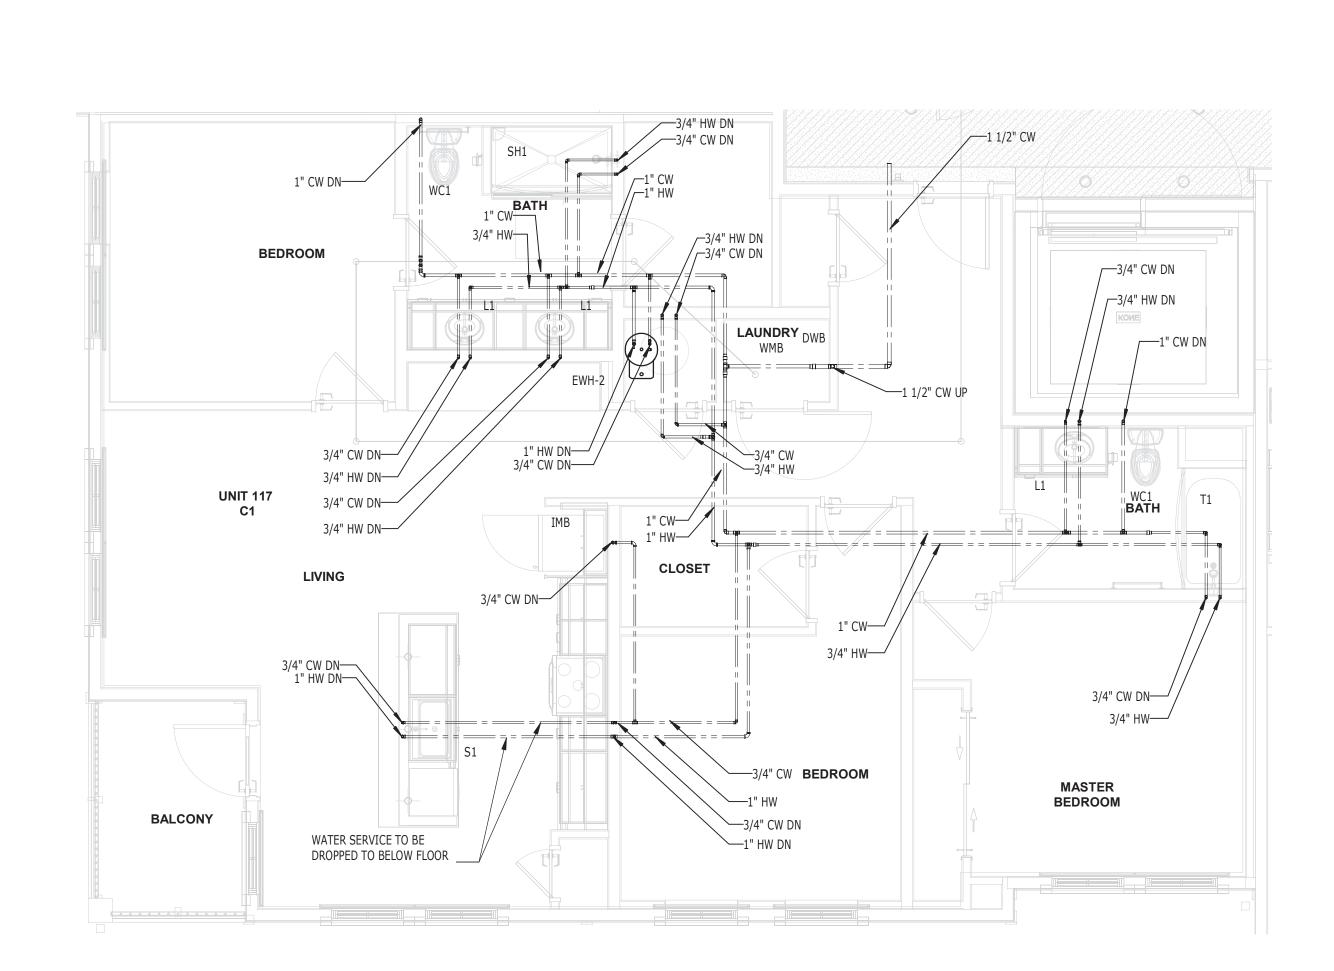2 UNIT C1 S- TYPICAL S,W&V PLAN 1/4" = 1'-0"



4 UNIT C1 - DOMESTIC WATER PLAN
1/4" = 1'-0"



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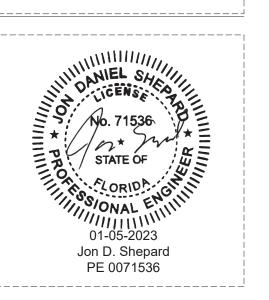
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PROJECT NO:

220035.00

SANITARY & DOMESTIC WATER UNIT PLANS

SHEET NUMBER: RP3.02

PLUMBING LEGENDS							
FIXTURE	DFU	DFU					
WC1	3	1					
T1	2	2					
L1	1	3					
SH1	2	4					
WMB	3	(5)					
S1\KS WITH D/W	2	6					
FD	2	7					





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SR-82

7780 LIGHTARD KNOTT LN FORT MYERS, FL 33905
PROJECT NO:

220035.00

SANITARY RISER DIAGRAMS

SHEET NUMBER: RP4.00

1 SANITARY / VENT RISERS

N.T.S

PROVIDE DOWNSTREAM SUDS ZONE NOT EXCEEDING 12'-0"

SA 3


PROVIDE DOWNSTREAM SUDS ZONE NOT EXCEEDING 12'-0"

PROVIDE UPSTREAM SUDS — ZONE

PROVIDE DOWNSTREAM SUDS— ZONE NOT EXCEEDING 12'-0"

EXTEND AND CONNECT TO SANITARY MAINS


PLUMBING LEGENDS									
FIXTURE	CWSFU	HWSFU	NOTE						
WC1	2.2	-	1						
T1	1	1	2						
L1	0.5	0.5	3						
SH1	1	1	4						
WMB	1	1	5						
S1 WITH D/W	1	2.4	6						
IMR	0.5	-	(7)						

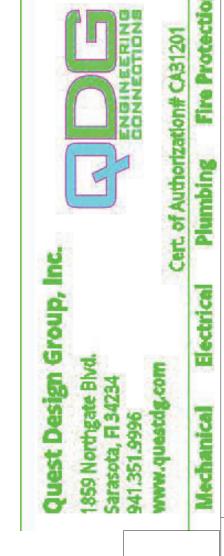


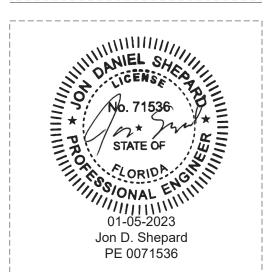
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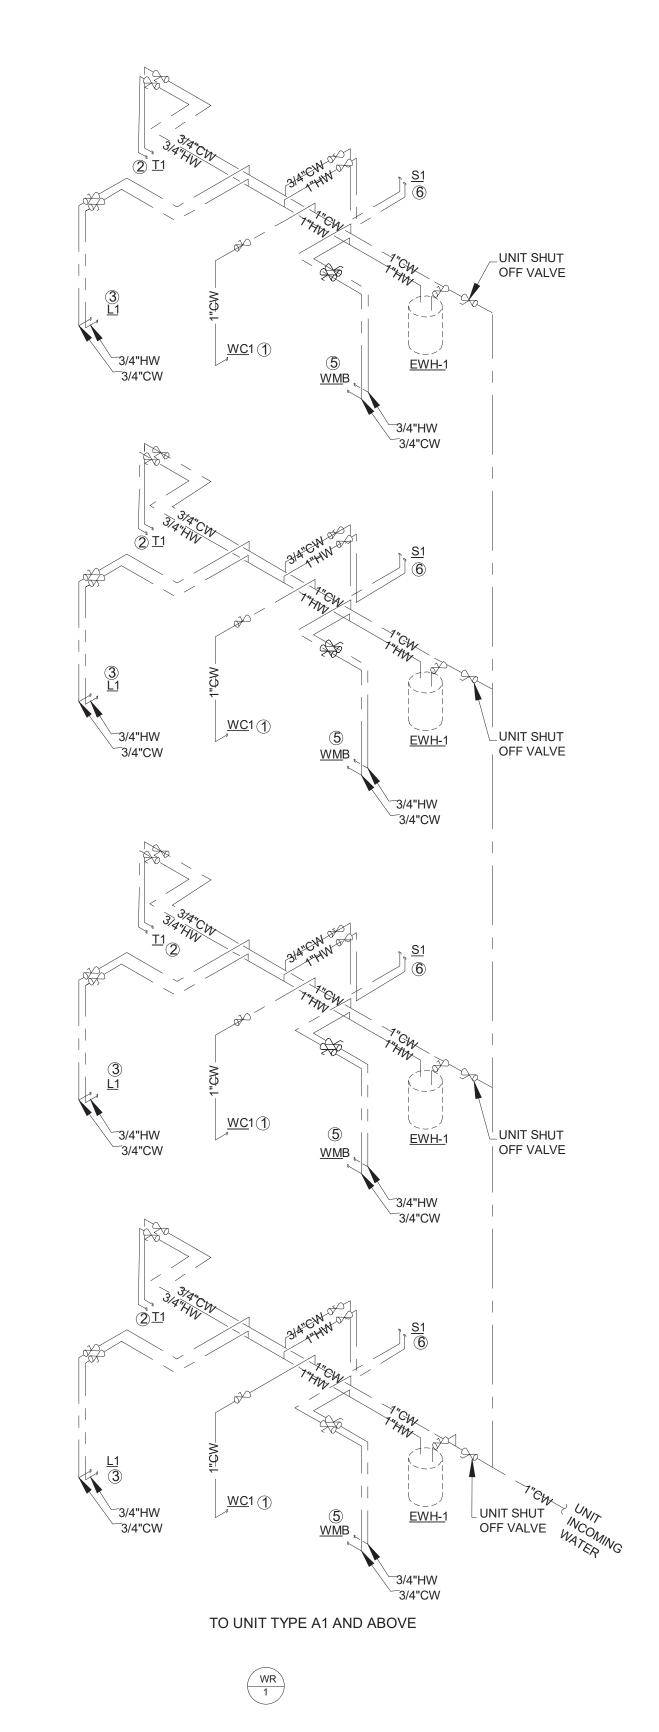
SR-82


7780 LIGHTARD KNOTT LN FORT MYERS, FL 33905

220035.00

DOMESTIC WATER RISER DIAGRAMS

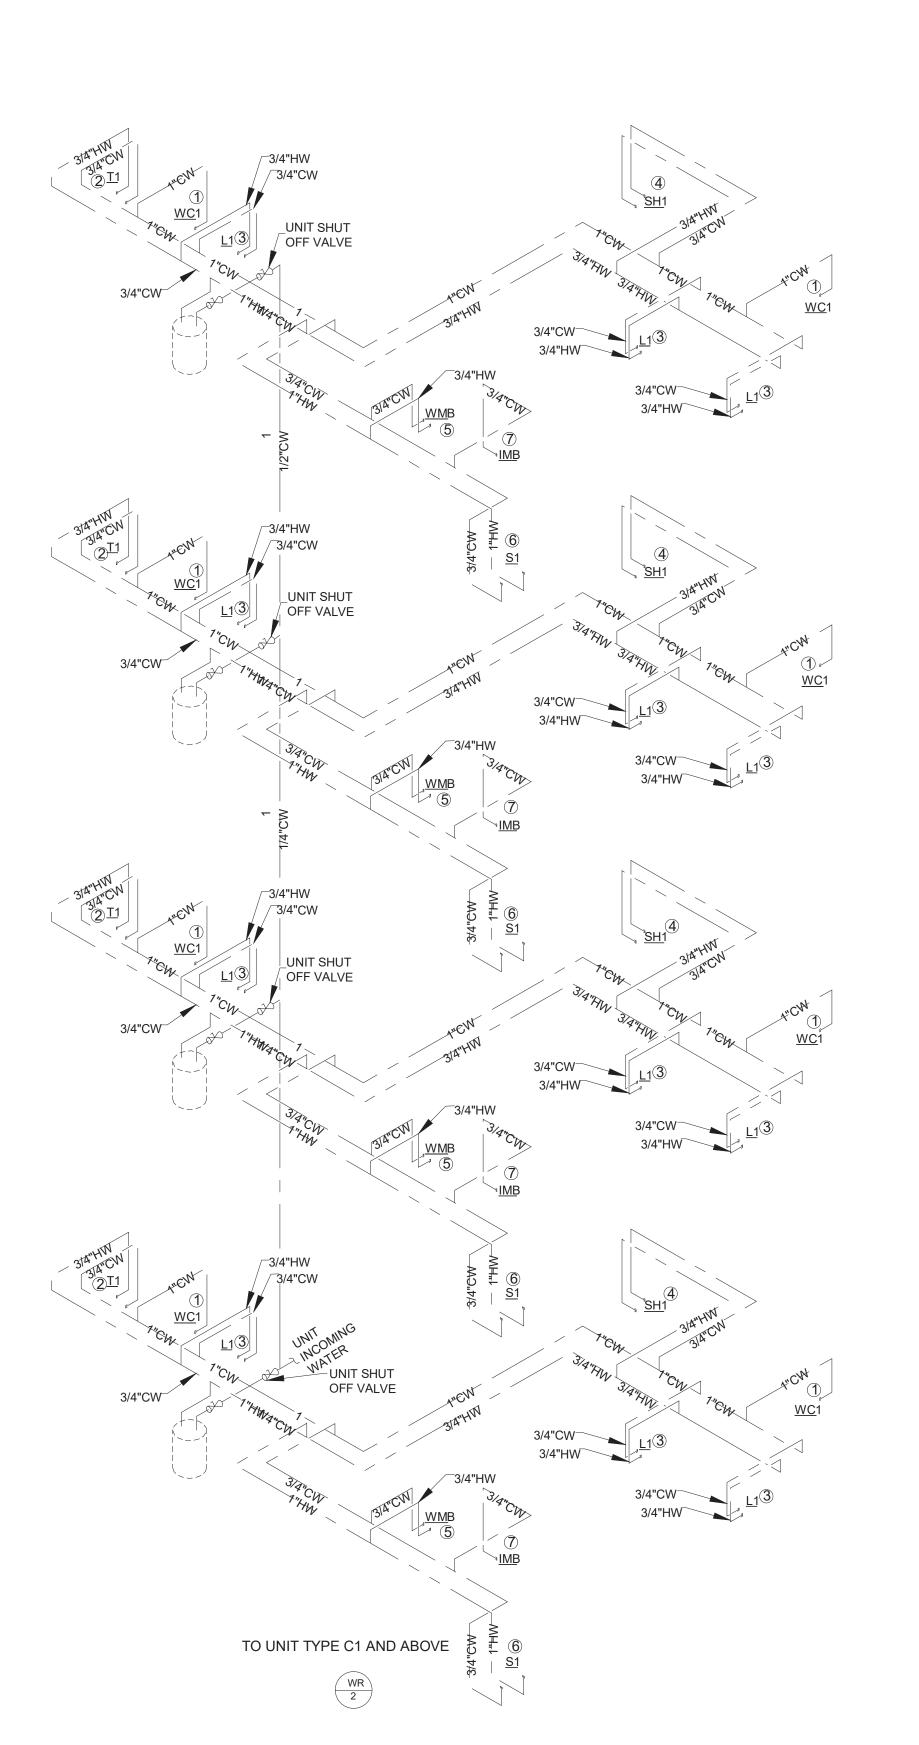
SHEET NUMBER: RP4.01





1 WATER RISERS


PL	PLUMBING LEGENDS								
FIXTURE	CWSFU	HWSFU	NOTE						
WC1	2.2	-	1						
T1	1	1	2						
L1	0.5	0.5	3						
SH1	1	1	4						
WMB	1	1	5						
S1 WITH D/W	1	2.4	6						
IMB	0.5	-	7						

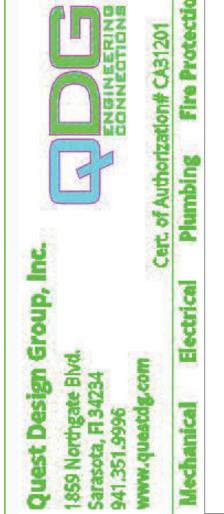



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PROJECT NO:

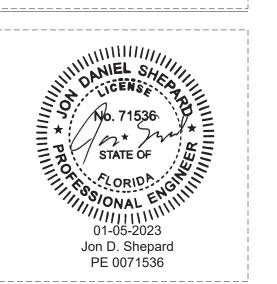
220035.00

SHEET NUMBER:

DOMESTIC WATER RISER DIAGRAMS

RP4.02

1"CW	3/4"CW 3/4"HW 3
3/4"CW 3/4"HW	MC1 LIEM - SO. 44
② <u>T1</u>	3/4"CW 7"CW 3/4"HW
	JUNIT SHUT
1"CW	OFF VALVE 3/4"CW 3/4"HW 3/4"HW 3/4"HW 4
3/4"CW 3/4"HW	UNIT SHUT OFF VALVE 314"CW 314"CW 314"HW
② <u>T1</u>	3/4"CW 3/4"CW 3/4"HW
	JUNIT SHUT
	OFF VALVE 3/4"CW 3/4"HW OFF VALVE OFF VA
3/4"CW 3/4"HW	UNIT SHUT OFF VALVE
② <u>I</u> 1	3/4"KW 3/4"CW 3/4"CW 3/4"HW
	JINIT SHUT
	OFF VALVE 3/4"CW 3/4"HW TIMB
1"CW=3/4"CW=3/4"HW=3/4"	UNIT SHUT OFF VALVE
② <u>T1</u>	3/4 MM 3 3 L1
	3/4"CW 3/4"CW 3/4"CW
	July Sull Sull Sull Sull Sull Sull Sull S
	OFF VALVE 314"CW 314"CW
	3/4"HW WC1 3/4"HW 3/4"CW
	TO UNIT TYPE B2 AND ABOVE 3/4"CW 3/4"CW 3/4"CW
	$\left(\begin{array}{c} WR \\ 3 \end{array}\right)$

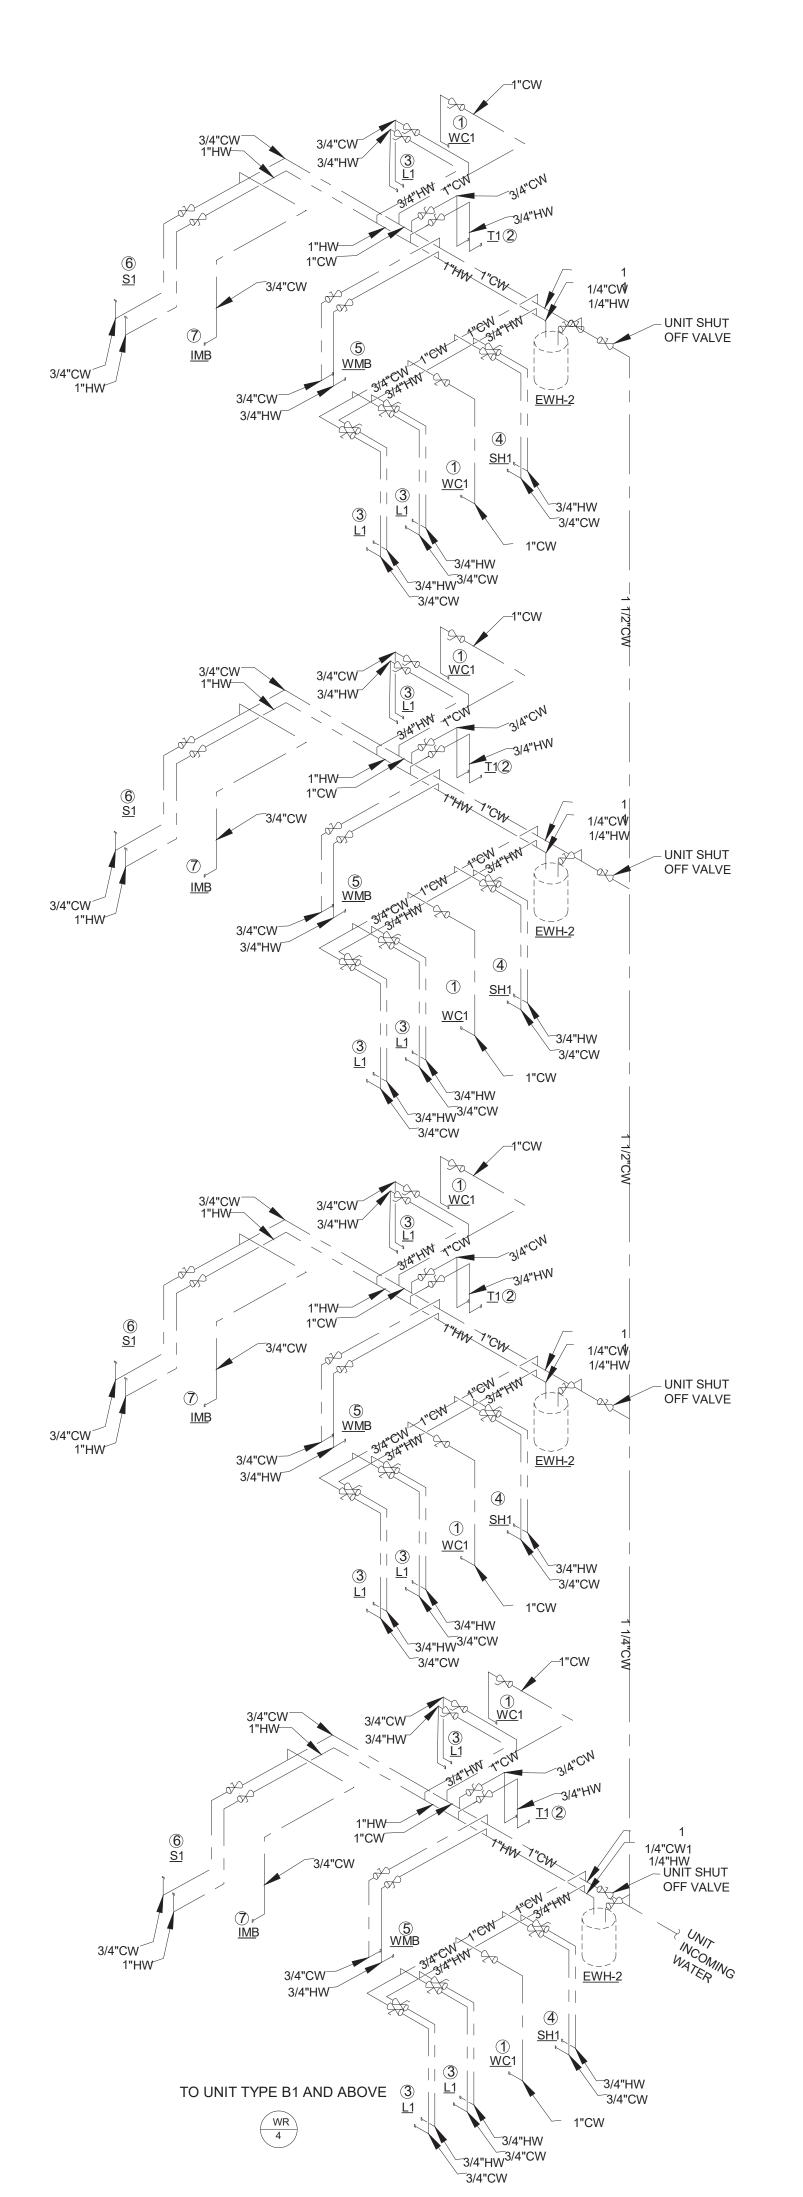


2 WATER RISERS
N.T.S

PLUMBING LEGENDS								
FIXTURE	CWSFU	HWSFU	NOTE					
WC1	2.2	-	1					
T1	1	1	2					
L1	0.5	0.5	3					
WMB	1	1	4					
S1 WITH D/W	1	2.4	5					
IMB	0.5	-	6					





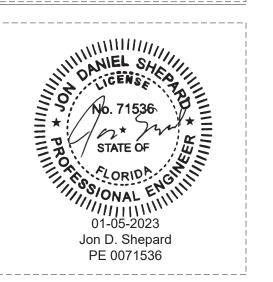

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KNOW SPECI	LEDGE AND ABILITY	VITH THE APPLICABLE				



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220035.00

DOMESTIC WATER RISER DIAGRAMS

SHEET NUMBER: RP4.03

3/4"CW ⁻ 3/4"HW ⁻

							PLUMBING FIXTURE S	SCHF	DUIF									
	FIXTURE TYPE																TURE UNITS	
TAG	QUANTITY	DESCRIPTION	TYPE	VALVE	FAUCET	MATERIAL	REMARKS	TDAD	WAST		_ -	OMESTIC		COLD	HOT WATER	TOTAL SUPPLY	SANITARY	
WC1	112	AMERICAN STANDARD MODEL #2467.016, "CADET" RIGHT-HEIGHT ELONGATED PRESSURE- ASSISTED		-	_	VITREOUS CHINA	Fixture performance and specifications meet or exceed ASME A112.19.2-2008/CSA B45.1-08 standards, and other state and local codes.	3"	3"	INDIRECT	2"	COLD 1"	-	2.2	0	246.4	336	
<u>L1</u>	147	LAVATORY	American Standard Lucerne 0355012PL020-1/ 2" Wall Mounted Porcelain Bathroom Sink		Manual Sink Faucets 802-317XKAB CP	VITREOUS CHINA	UNIT TO BE PROVIDED WITH LAVATORY CARRIER ASSEMBLY, OFF-SET GRID STRAINER ASSEMBLY WITH CHROME TAILPIECE AND CHROME P-TRAF ASSEMBLY, LOOSE KEY STOPS, ESCUTHEONS, ETC. UNIT TO BE PROVIDED WITH "TRUEBRO" VINYL PIPE INSULATION KIT.	1-1/2"	1-1/2"	-	2"	3/4"	3/4"	0.5	0.5	102.9	147	
<u>JS1</u>	2	MOP SINK	MSB2424 - 24" X 24" Molded Stone Mop Service Basin	-	Service-Sink Faucet Model: 830-AA	STAINLESS STEEL	Tiling flanges are optional, made of stainless steel, and extend 1" above the shoulder on 1, 2, or 3 sides, as required.	י	3"	-	2"	3/4"	3/4"	3	3	4.5	6	
<u>SH1</u>	36	SHOWER	-	-	-		2603SG 60 x 32 AcrylX Alcove Left-Hand Drain One-Piece Tub Shower in White		2"	-	2"	3/4"	3/4"	1	1	72	72	
<u>T1</u>	68	BATHTUB	-	-	-	-	-	-	-	-	-	-	-	1	1	136	136	
<u>UR</u>	2	-	-	-	-	VITREOUS CHINA	OPERATES IN THE RANGE OF 0.125 GPF TO 1.0 GPF	2"	2"	-	2"	1"	-	3	-	6	6	
<u>IMB</u>	68	ICE MAKER REFRIG.	WATTS #LF7RU2-2	-	-	NO-LEAD BRASS	NSF-372 compliant, IAPMO listed box and valve, ASSE 1010 arrester* Valve meets ASME A112.18.1	-	-	-	-	3/4"	-	1	-	68	-	
<u>FD</u>	69	FLOOR DRAIN	-	-	-	STAINLESS STEEL	FLOOR DRAIN TO BE PROVIDED IN ALL COMMON BATHROOM AREAS,INCLUDING SINGLE USER COMMON BATHROOMS.	3"	3"	-	-	-	-	-	-	-	276	
<u>WMB</u>	68	RESIDENTIAL WASHER/DRYE R	-	-	-	-	PROVIDE UNIT WITH GUY GRAY #82634 (MODEL #BED200GF) WMOB & GUY GRAY MODEL #350 DRYER BOX. UNIT TO BE PROIVDE WITH DRAIN PAN ASSEMBLY WITH DRAIN PIPED TO FLOOR DRAIN.	2"	2"	-	2"	3/4"	3/4"	18	18	95.2	204	
<u>S1</u>	71	KITCHEN SINK	-	-	-	STAINLESS STEEL	ASME A112.19.3/CSA B45.4	1-1/2"	1-1/2"	-	1-1/2"	3/4"	3/4"	1	2.4	203.77	142	
<u>DF1</u>	1	DRINKING FOUNTAIN	-	-	-	-	-	2"	2"	-	2"	3/4"	3/4"	1	1	2	2	

INSTALL BACKING AND SUPPORTS AS REQUIRED FOR ALL FIXTURES AND ACCESSORIES.

ALL FIXTURES SHALL MEET ADA AND LOCAL CODES

SUPPLY PIPING AND FITTING FOR ALL FIXTURES SHALL BE INSTALLED SO AS TO PREVENT BACKFLOW

DUPLEX PUMP -

ALL FIXTURES SHALL BE PROVIDED WITH ACCESSIBLE SHUT OFF VALVES AT COLD AND HOT WATER PIPING CONNECTIONS

PROVIDE INSULATION FOR ALL PIPING IN EXTERIOR WALLS.

ALL PLUMBING FIXTURES SHALL BE COORDINATED AND APPROVED BY ARCHITECT PRIOR TO PURCHASE.

HOT WATER TO ALL LAVATORIES AND HAND SINKS SHALL NOT EXCEED 110 DEGREES. COORDINATE ADA HEIGHT REQUIREMENTS WITH ARCHITECT DRAWINGS.

ALL HAND SINKS SHALL BE PROVIDED WITH APPROVED AUTOMATIC SAFETY WATER MIXING DEVICE AND PRESSURE BALANCE

516 SUPPLY FIXTURE UNITS FOR SPACE WHICH IS EQUAL TO 170 GPM AND REQUIRES NO LESS THAN A 3" PIPE.

600 DRAINAGE FIXTURE UNITS FOR THE SPACE WHICH REQUIRES NO LESS THAN 6" PIPE.

			E	LECTF	RIC WA	TER HEAT	ER SCH	HED	ULE						
				GE	NERAL							ELE	CTRICAL		
QUIPMENT	LOCATION	CAPACITY		DIMENSIONS (INCHES)					MOCD		VOL TO	NOTES			
TAG	LOCATION	MANUFACTURER	MODEL	UNIT TYPE	(GALLONS)	ONS) WEIGHT (LBS.)	DIAMETER	WIDTH	DEPTH	HEIGHT	MCA	MOCP	PHASE	VOLTS	
EWH-1	SEE PLAN	AO SMITH	ENLB-40	TANK TYPE	38	118	23"	23"	23"	32"	4.4	15.0	1.0	240.0	2,3,4
EWH-2	SEE PLAN	AO SMITH	ENLB-50	TANK TYPE	48	172	26 1/2"	26 1/2"	26 1/2"	34"	4.4	15.0	1.0	240.0	2,3,4
<u>NOTES</u>	HEATER PER APA 2. PROVIDE ONE \ 3.ACCEPTABLE E	RTMENT UNIT. WATER HEATER PER QUAL MANUFACTURE	APARTMENT U	JNIT. MITH, BRADFOR	D WHITE, LOCKIN'	ATE ELECTRICAL REQUIF	TE								

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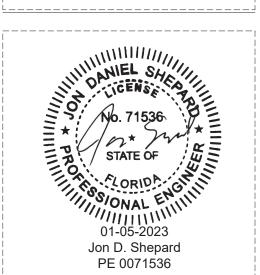
4. IF WATER HEATER IS SUPPLIED WITH AN INSULATION BLANKET TO MEET THE REQUIRED ENERGY FACTOR, THE BLANKET MUST BE PLENUM RATED. NON-PLENUM RATED BLANKETS SUPPLIED BY THE MANUFACTURER MUST BE REPLACED WITH AN INSULATION BL ANKET FROM AN INSULATION MANUFACTURER THAT IS PLENUM RATED. PLENUM RATED BLANKETS ARE NOT REQUIRED IF THE WATER HEATER IS NOT IN A PLENUM OR IS NOT LOCATED IN A CLOSET SHARED WITH HVAC EQUIPMENT.



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	INDIC OWNE ARCHI DEVEL SPECI ARRAN DISCL ANY P PERMI WARN OFFEN DISCL MISAF SEQ. A DESIG	ATED OR REPRESENT ID BY AND THE PROPI ITECTS, INC. AND WE LOPED FOR USE ON A FIED PROJECT. NONE WE WAS AND WE LOPED FOR USE ON A FIED PROJECT. NONE WAS AND WE WAS AND OTHER LAWS. THE SING: REPRODUCTION IN VICE OF THE WAS AND OTHER LAWS. THE WAS DISCLOSED HERE WAS DISCLOSED HERE WAS AND OTHER LAWS. THE WAS DISCLOSED HERE	ANGEMENTS AND PLANS ED BY THIS DRAWING ARE ERTY OF BAKER BARRIOS RE CREATED, EVOLVED, AND ND IN CONNECTION WITH THE OF THE IDEAS, DESIGNS, SHALL BE USED BY OR N, FIRM, OR CORPORATION FOR R WITHOUT THE WRITTEN RRIOS ARCHITECTS, INC. HEREOF IS A CRIMINAL SEC. 506 UNAUTHORIZED UTE TRADE SECRET LATION OF 1.C.24-2-31-1 ET. HE IDEAS, ARRANGEMENTS AND EIN MAY BE PATENTED OR BE PATENT APPLICATION.
-	KNOW SPECI	LEDGE AND ABILITY	VITH THE APPLICABLE



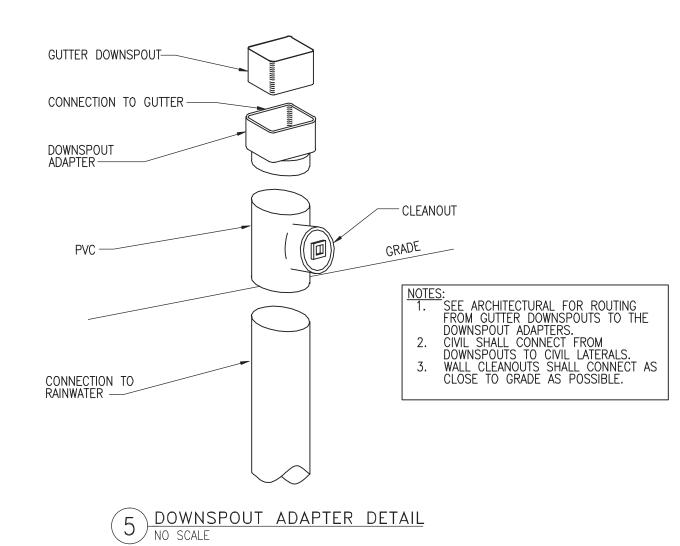
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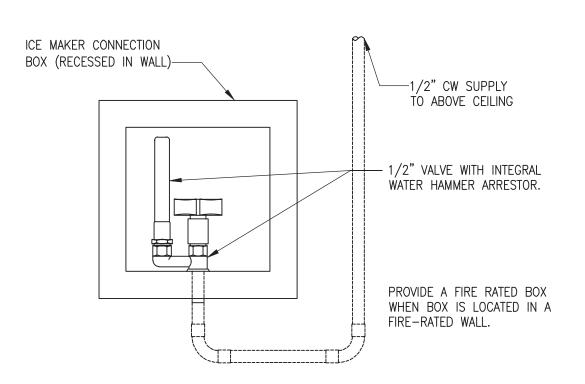
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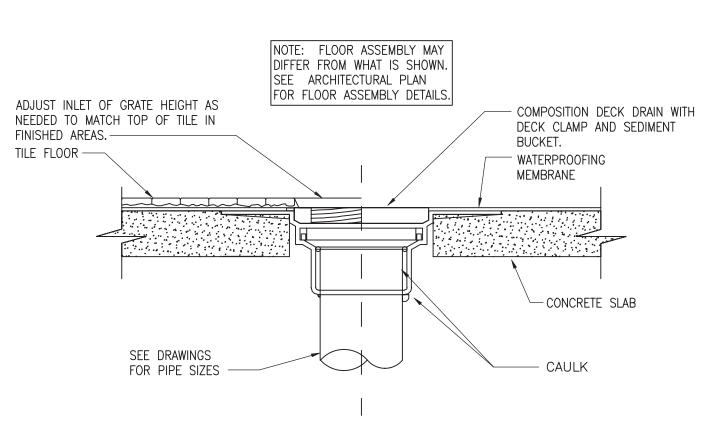
PLUMBING SCHEDULES

- 1. COORDINATE PIPING WITH MECHANICAL UNIT ABOVE. PIPING AND WATER HEATER CANNOT BE GREATER THAN 42" AFF. 2. DRAIN PAN AND ALL PRODUCTS IN THE APARTMENT MECHANICAL CLOSETS SHALL BE NON-COMBUSTIBLE AND MEET THE 25/50 FLAME/SMOKE DEVELOPED RATING
- PER ASTM E-84. 3. PVC PIPE IS NOT ALLOWED IN THE MECHANICAL CLOSETS. 4. WATER HEATER SHALL BE INSTALLED TO BE EASILY ACCESSIBLE FOR MAINTENANCE AND REPLACEMENT. SEE HVAC DRAWINGS FOR PLACEMENT OF WH IN RELATION TO FCU. 6. HEAT TRAPS OR HEAT TRAP NIPPLES ARE REQUIRED ON ALL WATER HEATERS.
 7. THE FIRST 8 FEET OF OUTLET PIPING SHALL BE INSULATED PER ASHRAE 90.1-2010 SECTION 7.4.3.
- 1 WATER HEATER DETAIL
 NO SCALE

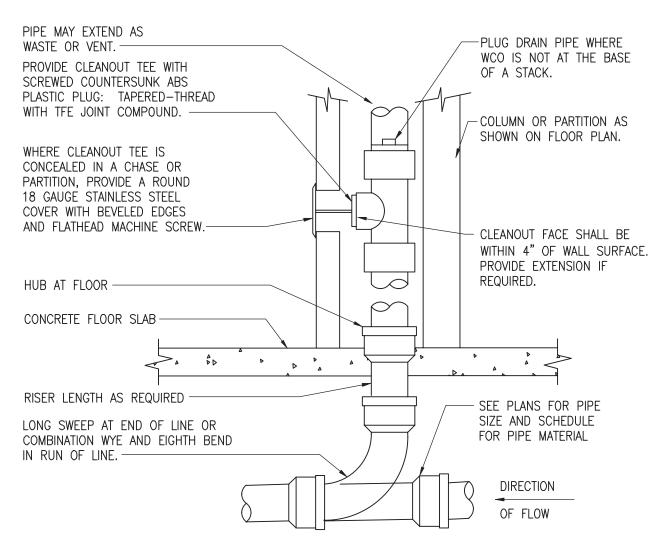




8 ICE MAKER BOX DETAIL
NO SCALE




2 FLOOR DRAIN DETAIL NO SCALE



PROVIDE WCO AT BASE OF ALL WASTE STACKS AND RAIN-LEADER DOWNSPOUTS. PROVIDE WCO WHERE SHOWN ON PLAN, AND ON SANITARY WASTE BRANCHES NOT SERVED WITH A FLOOR CLEANOUT. LOCATE ABOVE FIXTURE FLOOD RIM WITHIN 4' OF FLOOR. CONSULT LOCAL CODES FOR OTHER WCO REQUIREMENTS.


6 WALL CLEANOUT DETAIL
NO SCALE

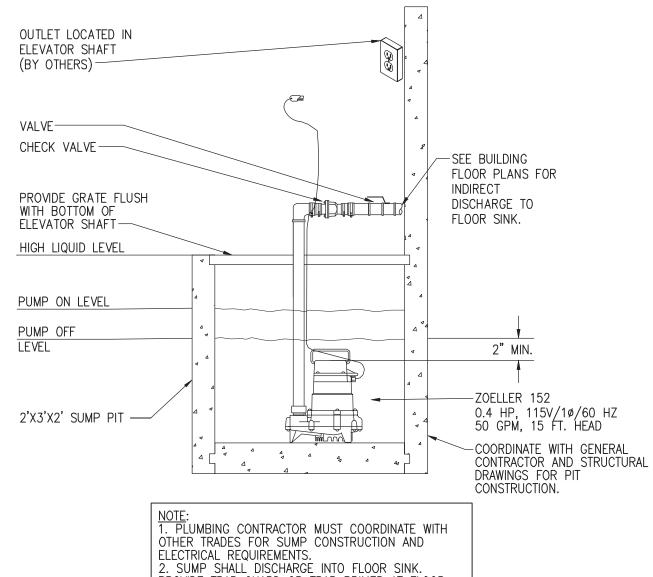9 WASHING MACHINE BOX DETAIL
NO SCALE PROVIDE FIRE RATED WMB WHEN INSTALLED ON A FIRE RATED WALL. SEE ARCHITECTURAL WALL TYPES.




3 ELEVATOR SUMP PUMP DETAIL
NO SCALE

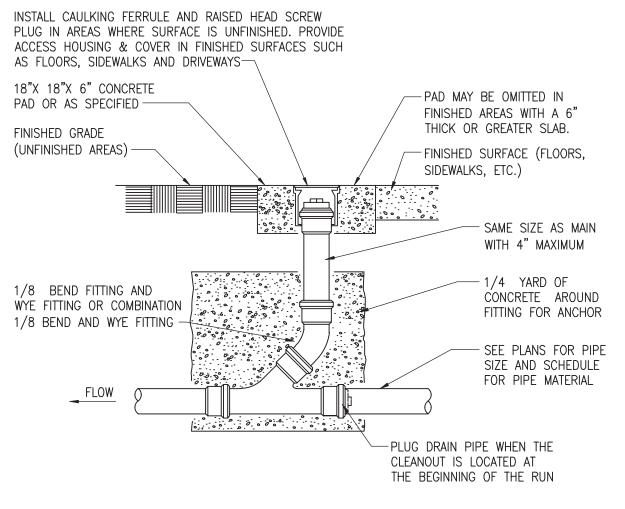
PROVIDE TRAP GUARD OR TRAP PRIMER AT FLOOR



7 FLOOR/GRADE CLEANOUT DETAIL
NO SCALE

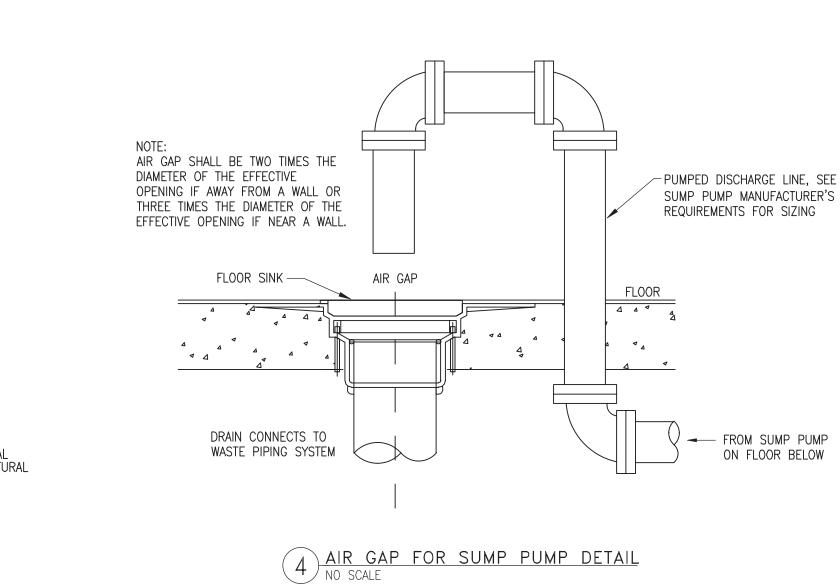

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CEILING

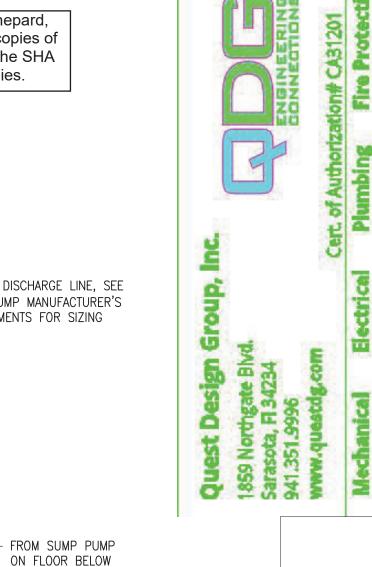PRESSURE GAUGE

✓ SHUT-OFF BALL VALVE (TYP)

— DIELECTRIC FLANGE

PSI. FIELD VERIFY.

11 DOMESTIC WATER SERVICE ENTRY

CW SERVICE B/G W/

ROD AND CLAMPS -

THRUST BLOCK-

— SEE PLANS FOR PIPE SIZE

PRV ASSEMBLY REQUIRED IF STATIC PRESSURE AT

X" DOMESTIC WATER SERVICE FOR XXX GPM, SEE CIVIL FOR CONTINUATION AND WATER METER

LOCATION AND SIZE. METER TO BE SIZED BASED ON FLOW RATE AND LOCAL UTILITY REQUIREMENTS AND SHALL NOT BE SIZED SIMPLY BY MATCHING


POINT OF ENTRY IN THE BUILDING EXCEEDS 80

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Jon D. Shepard

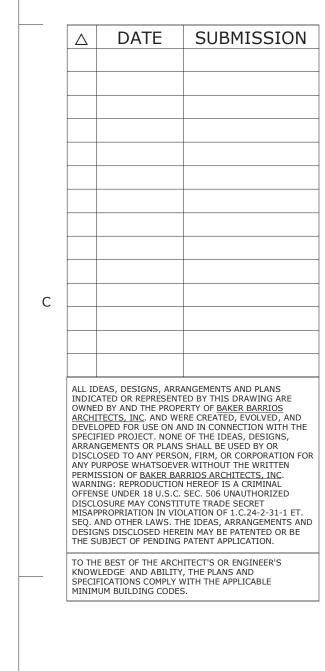PE 0071536





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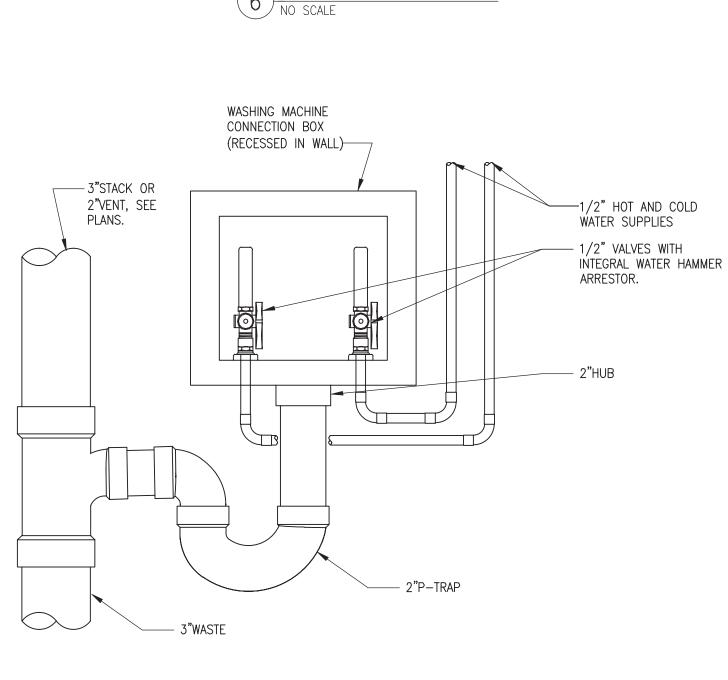
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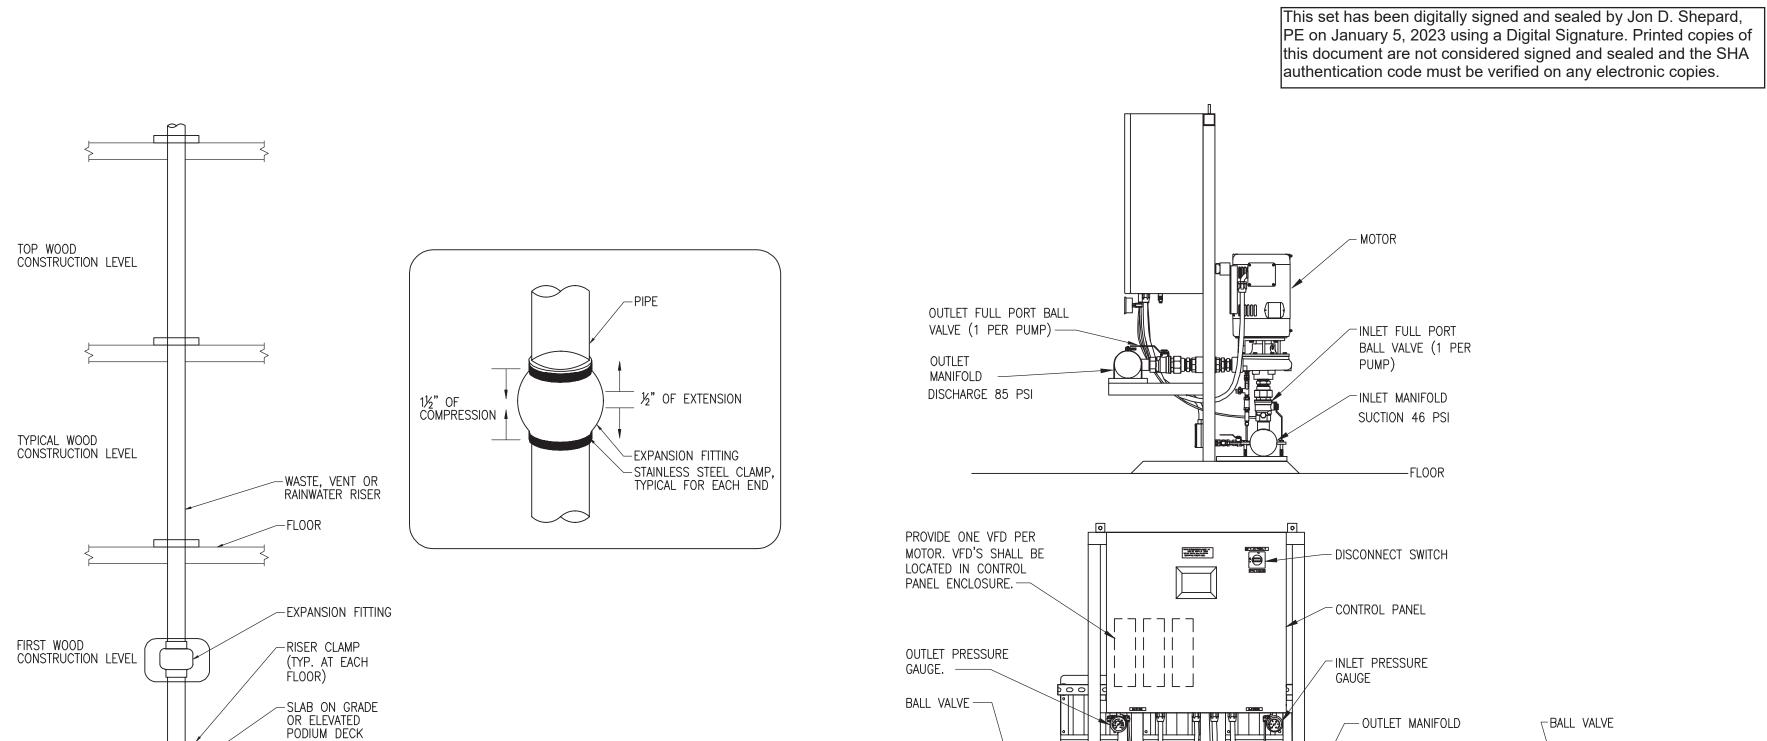
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PLUMBING DETAILS

RP6.00





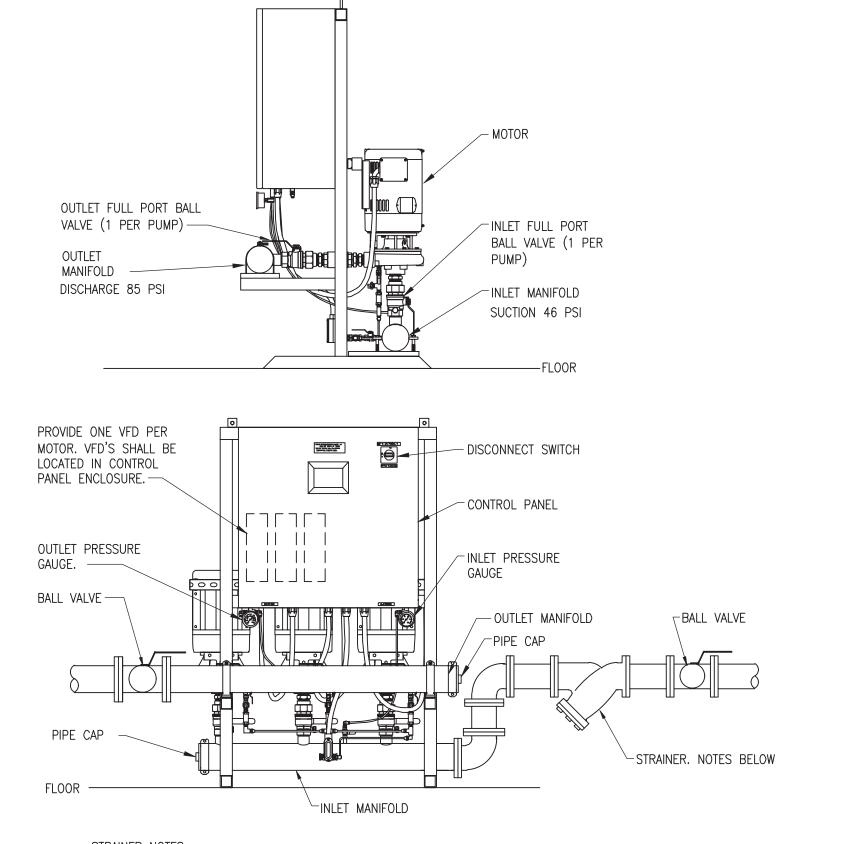
NOTES:

1. EXPANSION FITTING SHALL BE EQUAL TO FERNCO XJ SERIES.

2. PROVIDE EXPANSION FITTINGS ON ALL VERTICAL SANITARY, WASTE, VENT OR RAINWATER RISERS ROUTED THROUGH WOOD CONSTRUCTION. EXPANSION FITTING SHALL BE LOCATED ON THE FIRST WOOD CONSTRUCTED FLOOR AND EVERY ALTERNATING FLOOR ABOVE THE FIRST LEVEL. 3. INSTALL EXPANSION FITTING 4'-0" ABOVE FLOOR HEIGHT. 4. EXPANSION FITTINGS SHALL BE INSTALLED TO ALLOW A MINIMUM OF 1½" OF COMPRESSION AND ½" EXTENSION FROM NORMAL POSITION.


5. PROVIDE RISER CLAMPS AT THE BASE OF EACH STACK ON EACH FLOOR.

1 EXPANSION FITTING DETAIL NO SCALE




STRAINER NOTES:
STRAINER MUST HAVE ENOUGH CLEARANCE ABOVE FLOOR & ADJACENT PIPE FOR REMOVAL OF BASKET. STRAINER SHALL NOT HAVE A PRESSURE DROP GREATER THAN 2 PSI @ FULL FLOW CONDITIONS, (SEE TABLE THIS SHEET) BASKET HOLES SHALL NOT BE GREATER THAN ¼". BASKET SHALL BE STAINLESS STEEL, WILKINS MODEL FS OR EQUAL.

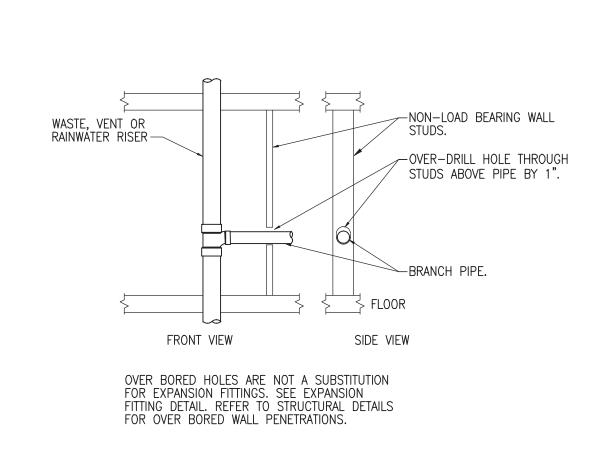
2 DOMESTIC PUMP DIAGRAM SCALE:NO SCALE



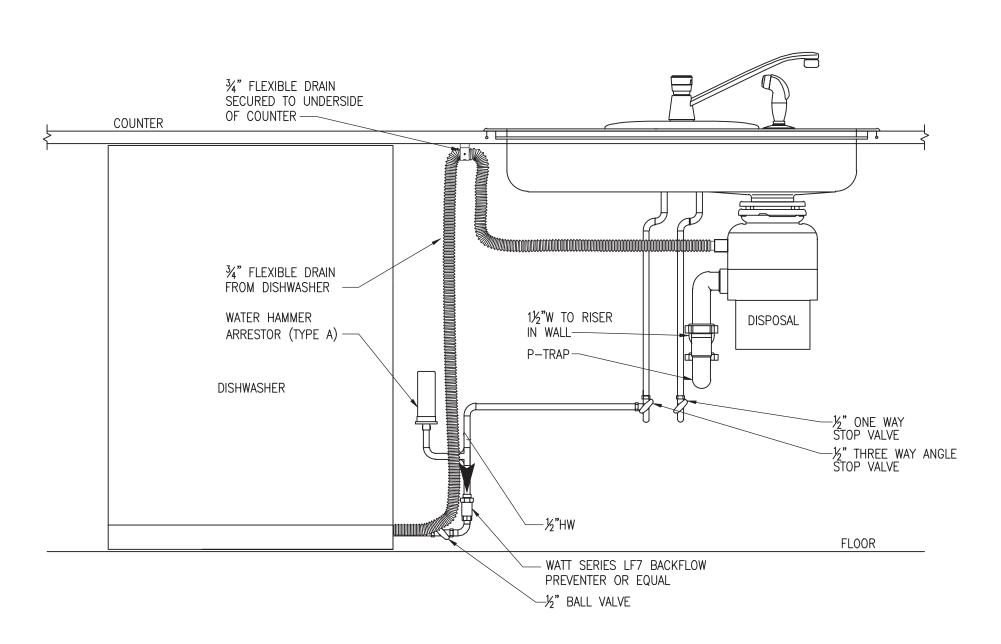3 PIPE WALL STUD PENETRATION DETAIL NO SCALE




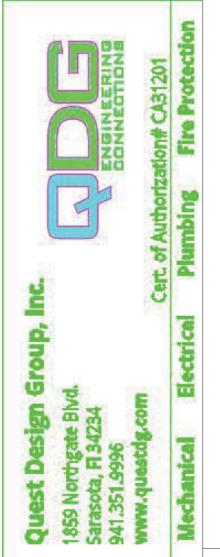4 DISHWASHER/DISPOSAL PIPING DETAIL NO SCALE



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TO THE BEST OF THE ARCHITECT'S OR ENGINEER'S KNOWLEDGE AND ABILITY, THE PLANS AND SPECIFICATIONS COMPLY WITH THE APPLICABLE MINIMUM BUILDING CODES.

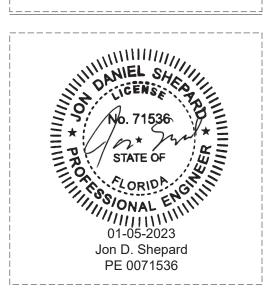

SR-82

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PLUMBING DETAILS

SHEET NUMBER: RP6.01

1. DRAWINGS ARE DIAGRAMMATIC AND INDICATE THE GENERAL ARRANGEMENT OF SYSTEMS AND WORK INCLUDED IN THE CONTRACT. DRAWINGS ARE NOT TO BE SCALED. THE ARCHITECTURAL DRAWINGS AND DETAILS SHALL BE EXAMINED FOR EXACT LOCATION OF FIXTURES AND EQUIPMENT. SYSTEMS SHALL INCLUDE ALL APPURTENANCES AS REQUIRED TO ACHIEVE THE OPERATING CONDITIONS AS SHOWN AND SPECIFIED AND SHALL RESULT IN A SUPERIOR INSTALLATION. INFORMATION CONTAINED ON THE DRAWINGS BUT NOT IN THE SPECIFICATIONS OR IN THE SPECIFICATIONS BUT NOT ON THE DRAWINGS ARE INTENDED TO BE IN BOTH. MINOR DETAILS NOT USUALLY SHOWN OR SPECIFIED BUT NECESSARY FOR PROPER OPERATION AND CONSISTENT WITH GOOD WORKMANSHIP WILL BE INCLUDED IN THE ESTIMATE, THE SAME AS IF SHOWN ON THE DRAWINGS. ANY CONFLICT SHALL BE IMMEDIATELY BROUGHT TO THE ATTENTION OF THE ARCHITECT

OR ENGINEER BEFORE PROCEEDING WITH THE WORK. 2. THE PLUMBING CONTRACTOR SHALL FURNISH ALL EQUIPMENT, MATERIAL, LABOR, ETC. NECESSARY TO PROVIDE A COMPLETE, WORKABLE AND CODE APPROVED PLUMBING SYSTEM. ALL WORK SHALL BE DONE IN ACCORDANCE WITH THESE PLANS AND SPECIFICATIONS, LOCAL, STATE AND NATIONAL

3. THE PLUMBING CONTRACTOR SHALL GIVE ALL NECESSARY NOTICES, OBTAIN ALL PERMITS AND PAY ALL GOVERNMENT FEES, SALES TAXES AND OTHER COSTS IN CONNECTION WITH HIS WORK; FILE ALL NECESSARY APPROVALS OF ALL GOVERNMENTAL DEPARTMENTS HAVING JURISDICTION; OBTAIN ALL REQUIRED CERTIFICATES OF INSPECTION FOR HIS WORK; AND DELIVER TO THE ARCHITECT THE SAME CERTIFICATES BEFORE REQUEST FOR ACCEPTANCE AND FINAL PAYMENT FOR THE WORK.

4. ALL WORK SHALL BE GUARANTEED, BOTH MATERIAL AND INSTALLATION, FOR A PERIOD OF ONE YEAR FROM ACCEPTANCE BY OWNER.

5. FURNISH SIX (6) COPIES OF SHOP DRAWINGS OF EQUIPMENT OR FIXTURES FOR APPROVAL PRIOR

6. CONTRACTOR SHALL KEEP A RECORD OF THE LOCATIONS OF ALL CONCEALED WORK AND UPON COMPLETION OF THE JOB, SHALL SUPPLY ACAD QUALITY AS-BUILT DRAWINGS SHOWING ANY DEVIATION FROM THE ORIGINAL DRAWINGS. THESE DRAWINGS SHALL INDICATE DIMENSIONS OF BURIED UTILITY LINES FROM BUILDING WALLS.

7. THE PLUMBING CONTRACTOR SHALL COORDINATE WITH ALL TRADES FOR PIPE ROUTING AND INSTALLATION OF EQUIPMENT AND SYSTEMS TO PROVIDE FOR REQUIRED CLEARANCES.

8. ALL OPENINGS THROUGH FIRE RATED WALLS OR FLOORS SHALL BE SEALED WITH A U.L. LISTED PENETRATION AND SHALL MAINTAIN THE FIRE RATED INTEGRITY OF THE WALL OR FLOOR. THE

CONTRACTOR SHALL VERIFY FIRE RATINGS WITH ARCHITECTURAL DRAWINGS PRIOR TO INSTALLATION

9. PIPE PASSING THROUGH PIT WALLS, BUILDING WALLS, AND BUILDING FLOORS BELOW GRADE SHALL BE PROVIDED WITH SLEEVES OF STANDARD WEIGHT GALVANIZED STEEL PIPE. THE ANNULAR SPACES BETWEEN PIPE AND SLEEVES SHALL BE SEALED WITH LINK SEAL HYDROSTATIC PIPE WALL SEAL. SLEEVES SHALL BE SIZED AS FOLLOWS:

3" PIPE - 6" ID SLEEVE 4" PIPE - 8" ID SLEEVE

PLUMBING GENERAL NOTES:

6" PIPE - 10" ID SLEEVE 8" PIPE - 12" ID SLEEVE

10" PIPE - 12" ID SLEEVE

WALL THICKNESS OF MATERIAL IS TO BE 0.025 INCH.

10. BREAKAGE AND CORROSION: PIPES PASSING UNDER OR THROUGH WALLS SHALL BE PROTECTED FROM BREAKAGE. PIPES PASSING THROUGH CONCRETE OR CINDER WALLS AND FLOORS OR OTHER CORROSIVE MATERIAL SHALL BE PROTECTED AGAINST EXTERNAL CORROSION BY A PROTECTIVE SHEATHING OR WRAPPING OR OTHER MEANS THAT WILL WITHSTAND ANY REACTION FROM LIME AND ACID OF CONCRETE, CINDER OR OTHER CORROSIVE MATERIAL. SHEATHING OR WRAPPING SHALL ALLOW FOR EXPANSION AND CONTRACTION OF PIPING TO PREVENT ANY RUBBING ACTION. MINIMUM

11. PROVIDE WALL CARRIERS FOR ALL WALL HUNG PLUMBING FIXTURES. ALL WALL HUNG PLUMBING FIXTURES SHALL BE CAPABLE OF SUPPORTING A 250 POUND VERTICAL LOAD.

12. THE PLUMBING CONTRACTOR SHALL VERIFY SIZE AND LOCATION OF ALL EXISTING SERVICES PRIOR TO COMMENCING WITH THE WORK.

13. CONTRACTOR SHALL EXTEND AS NECESSARY AND CONNECT BUILDING DRAIN AND POTABLE WATER LINES TO EXISTING SERVICE LINES AT LOCATION ON SITE OR IN BUILDING AS REQUIRED. VERIFY EXACT LOCATION AND INVERT ELEVATION OF SERVICE CONNECTIONS PRIOR TO CONSTRUCTION. CONTRACTOR SHALL NOTIFY ENGINEER IMMEDIATELY IF THE DISTANCE TO SITE SERVICES EXCEED TEN (10) LINEAR FEET FROM THE BUILDING.

14. OFFER REMOVED MATERIAL TO THE OWNER. REMOVE ALL MATERIAL REJECTED BY THE OWNER FROM THE WORK SITE AND DISPOSE OF IN ACCORDANCE WITH APPLICABLE LOCAL, STATE AND NATIONAL CODES. CONTRACTOR MUST CERTIFY TO OWNER THAT THE MATERIAL HAS BEEN LEGALLY

POTABLE WATER PIPING:

15. BELOW GROUND WATER PIPING SHALL BE TYPE "K" COPPER WITH VINYL SLEEVE FOR CORROSION PROTECTION WITH WROUGHT COPPER FITTINGS AND 95-5 SOLDERED JOINTS.

16. ABOVE GROUND WATER PIPING SHALL BE TYPE "L" COPPER WITH WROUGHT COPPER FITTINGS AND 95-5 SOLDERED JOINTS.

17. INTERIOR ABOVE AND BELOW GROUND WATER PIPING SHALL BE (CPVC) CHLORINATE POLYVINYL CHLORIDE PLASTIC PIPE AND TUBING (ASTM D-2846) FLOWGUARD OR EQUIVALENT WITH APPROVED CPVC SOLVENT WELDED FITTINGS. CPVC WATER PIPING SHALL NOT BE RUN IN RETURN AIR PLENUM OR FIRE RATED ASSEMBLIES UNLESS ALLOWED BY LOCAL JURISDICTION.

17a. INTERIOR ABOVE AND BELOW GROUND WATER PIPING SHALL BE CROSSLINKED POLYETHYLENE (PEX-a) STRAIGHT, COILED AND EXPANSION LOOPED PIPE AND TUBING (ASTM F876 AND F877) UPONOR AQUAPEX WHITE OR EQUIVALENT WITH COLD-EXPANSION FITTINGS (ASTM F877 AND F1960), LEAD FREE DEZINCIFICATION RESISTAND BRASS COUPLINGS, FITTINGS AND VALVES (ASTM F877 AND F1960) FOR ABOVE AND UNDERGROUND INSTALLATIONS AND/OR ENGINEERED POLYMER (ASTM F877 AND F1960) FOR ABOVE GROUND INSTALLATIONS. PEX-a WATER PIPING SHALL NOT BE RUN IN RETURN AIR PLENUM UNLESS INSTALLED PER MANUFACTURER'S WRITTEN INSTRUCTIONS FOR RETURN AIR PLENUM INSTALLATION AND APPROVED BY LOCAL JURISDICTION. PEX MANUFACTURE SHALL PROVIDE SHOP DRAWINGS INDICATING THE SYSTEM(S) HAVE BEEN ANALYZED FOR USE OF PEX PIPING FOR THIS APPLICATION.

18. EXTERIOR BUILDING SERVICE SHALL BE SCHEDULE 40 PVC (ASTM D-1785) WITH APPROVED PVC SOLVENT WELDED FITTINGS.

19. INTERIOR ABOVE AND BELOW GRADE HIGH TEMPERATURE HOT WATER (140°F OR GREATER) PIPING SHALL BE TYPE "L" HARD DRAWN COPPER TUBE WITH COPPER FITTINGS AND 95-5 SOLDERED JOINTS.

20. THE SITE SUBCONTRACTOR SHALL PROVIDE THE BACKFLOW PREVENTOR AND THE WATER METER. 21. A SERVICE VALVE SHALL BE PROVIDED ON THE DOMESTIC WATER RISER AT 5'-0" ABOVE FINISHED

FLOOR, WHERE WATER ENTERS THE BUILDING. 22. PROVIDE WATER HAMMER ARRESTORS ON HOT AND COLD WATER LINES ON ALL QUICK CLOSING DEVICES PER CHAPTER 6 OF FLORIDA BUILDING CODE PLUMBING.

23. PROVIDE VACUUM BREAKERS AS REQUIRED BY CODE.

ANCHORING PIPES AT THE BASE OF ALL RISERS.

24. TEST ALL WATER PIPING AT 100 PSIG FOR TWENTY-FOUR (24) HOURS OR AS REQUIRED BY CODE. 25. STERILIZE ALL WATER PIPING IN ACCORDANCE WITH HEALTH DEPARTMENT REGULATIONS AND AMERICAN WATER WORKS SPECIFICATIONS.

26. SUPPORT ALL WATER PIPING WITH PIPE HANGERS BY GRINNELL OR EOUAL.

27. PROVIDE RISER CLAMPS AT EACH FLOOR FOR ALL VERTICAL PIPING INCLUDING SANITARY DRAINS, VENTS, AND WATER LINES. INSTALL RISERS SO AS TO ALLOW VERTICAL MOVEMENT OF PIPING,

28. PROVIDE ACCESS DOORS WHERE NECESSARY TO SERVICE SEALS, VALVES, TRAPS, CLEAN-OUTS. AIR CHAMBERS/WATER HAMMER ARRESTORS, ETC. ALL ACCESS DOORS IN TOILET ROOMS SHALL BE STAINLESS STEEL.

29. PROVIDE DIELECTRIC UNIONS OR FITTINGS WHENEVER FERROUS AND NON-FERROUS PIPES ARE

30. INSULATE HOT WATER PIPING WITH 1 INCH ARMSTRONG AP ARMAFLEX UP TO AND INCLUDING 1 1/4-INCH DIAMETER. SECURE WITH ADHESIVE.

31. INSULATE HOT WATER PIPING OVER 1 1/4-INCH WITH 1 INCH THICK FIBERGLASS PIPE COVERING FINISHED WITH WHITE MASTIC. FITTINGS SHALL BE INSULATED WITH MITERED PIPE COVERING FINISHED WITH WHITE MASTIC OR PVC FITTING COVERS.

32. HANDICAPPED LAVATORIES: INSULATE WATER SUPPLIES AND WASTE PIPING REQUIRING ADA CONFORMANCE, WITH LAV-GUARD KITS, BY TRUEBRO OR EQUAL.

33. THIS SYSTEM WAS DESIGNED TO 50 PSI STATIC PRESSURE WITH RESIDUAL PRESSURE OF 20 PSI AT 1000 GPM FROM THE NEAREST FIRE HYDRANT. THESE CONDITIONS SHALL BE VERIFIED BY THE PLUMBING CONTRACTOR PRIOR TO PROCEEDING WITH THE INSTALLATION. NOTIFY THE ENGINEER IMMEDIATELY IF FLOW AND PRESSURES OBTAINED ARE BELOW THOSE CONTAINED IN THIS

34. WATER HEATERS: WATER HEATERS MUST BEAR ASHRAE LABEL INDICATING COMPLIANCE WITH ASHRAE STANDARD 90 OR COMPLY WITH EFFICIENCY AND STANDBY LOSS REQUIREMENTS. SWITCH OR CLEARLY MARKED CIRCUIT BREAKER (ELECTRIC) OR CUT-OFF (GAS) MUST BE PROVIDED. HEAT TRAPS REQUIRED. MUST MEET MINIMUM WATER HEATING EQUIPMENT EFFICIENCIES AS ESTABLISHED BY THE FLORIDA MODEL ENERGY CODE.

SANITARY WASTE, VENT AND STORM PIPING

OR AS REQUIRED BY THE BUILDING DEPARTMENT.

FRESH AIR INTAKES.

35. SANITARY WASTE AND VENT PIPING SHALL BE SCHEDULE 40 PVC (ASTM D-2665) WITH APPROVED PVC SOLVENT WELDED FITTINGS. COMPLY WITH 2020 FLORIDA BUILDING CODE. PVC PIPING SHALL NOT BE RUN IN RETURN AIR PLENUM OR FIRE RATED ASSEMBLIES.

36. SANITARY WASTE AND VENT PIPING SHALL BE SERVICE WEIGHT CAST IRON, NO-HUB WITH STAINLESS STEEL CLAMPS AND SHIELDS WITH NEOPRENE SEALING SLEEVES.

WASTE PIPING SHALL BE SLOPED AT 1/8" PER FOOT. 38. TEST SANITARY WASTE AND VENT PIPING BY A 10' WATER COLUMN FOR TWENTY-FOUR (24) HOURS

37. ALL SOIL AND WASTE PIPING, 2-1/2" AND SMALLER, SHALL BE SLOPED AT 1/4" PER FOOT. LARGER

39. ALL VENTS THROUGH ROOF SHALL BE A MINIMUM OF 10'-0" OR AS REQUIRED BY CODE AWAY FROM AND VALVES 2-1/2" AND SMALLER ARE TO HAVE SOLDERED OR SCREWED CONNECTION AND 3" AND FRESH AIR INTAKES.

40. ALL VENTS THROUGH ROOF SHALL BE PROVIDED WITH FOUR (4) POUND SHEET LEAD FLASHING EXTENDING UPWARD AROUND THE PIPE AND TURNED DOWN INSIDE THE PIPE.

41. FLOOR DRAINS TO HAVE 4-INCH DEEP SEAL TRAPS. EXACT DRAIN LOCATION SHALL BE COORDINATED WITH ARCHITECT PRIOR TO ROUGH IN.

42. FLOOR SINKS TO HAVE 4-INCH DEEP SEAL TRAPS. EXACT DRAIN LOCATION SHALL BE

COORDINATED WITH ARCHITECT PRIOR TO ROUGH IN. 43. PROVIDE ASSE 1072 CERTIFIED TRAP SEAL BARRIERS FOR ALL FLOOR DRAINS AND HUB DRAINS

THAT ARE NOT CONTINUOUSLY WASHED BY AN APPLIANCE OR FIXTURE. 44. SANITARY WASTE, VENT AND STORM PIPING SHALL BE SCHEDULE 40 PVC (ASTM D-2665) WITH

APPROVED PVC SOLVENT WELDED FITTINGS. COMPLY WITH 2020, 7th EDITION FLORIDA BUILDING CODE. PVC PIPING SHALL NOT BE RUN IN RETURN AIR PLENUM OR FIRE RATED ASSEMBLIES.

STAINLESS STEEL CLAMPS AND SHIELDS WITH NEOPRENE SEALING SLEEVES.

EXTENDING UPWARD AROUND THE PIPE AND TURNED DOWN INSIDE THE PIPE.

46. ALL SOIL AND WASTE PIPING, 2-1/2" AND SMALLER, SHALL BE SLOPED AT 1/4" PER FOOT. LARGER SHALL FIT SNUGLY AROUND THE PIPE. WASTE PIPING SHALL BE SLOPED AT 1/8" PER FOOT.

47. INSULATION FIT: INSULATION SHALL BE APPLIED TO PIPE AND EQUIPMENT WITH ALL JOINTS FITTED TO ELIMINATE VOIDS. VOIDS SHALL NOT BE FILLED WITH JOINT SEALANT, BUT SHALL BE

ELIMINATED BY REFITTING OR REPLACING INSULATION. 48. ALL VENTS THROUGH ROOF SHALL BE A MINIMUM OF 10'-0" OR AS REQUIRED BY CODE AWAY FROM

49. ALL VENTS THROUGH ROOF SHALL BE PROVIDED WITH FOUR (4) POUND SHEET LEAD FLASHING

50. PROVIDE AND INSTALL SHUT OFF VALVES AND SECTIONAL VALVES AS REQUIRED BY APPL FLORIDA BUILDING CODES AND PLUMBING SPECIFICATION SECTIONS.

51. PIPE ROUTING IS SHOWN DIAGRAMMATICALLY AND DOES NOT SHOW ALL OFFSETS, DROP RISES OF RUNS. THE CONTRACTOR SHALL ALLOW IN HIS PRICE FOR ROUTING OF PIPE TO AV OBSTRUCTIONS. COORDINATION WITH UTILITY SERVICES, INCLUDING THOSE OF OTHER TRA REQUIRED. MAINTAIN HEADROOM AND SPACE LOCATIONS.

52. INSTALL WORK AS TO BE READILY ACCESSIBLE FOR OPERATION, MAINTENANCE, AND REP MINOR DEVIATIONS FROM DRAWINGS MAY BE MADE TO ACCOMPLISH THIS, BUT CHANGES W INVOLVE EXTRA COST SHALL NOT BE MADE WITHOUT APPROVAL.

53. ALL MATERIALS AND EQUIPMENT TO BE NEW UNLESS OTHERWISE NOTED AND SHALL BE I ACCORDANCE WITH BUILDING STANDARDS. ALL MATERIALS AND EQUIPMENT ON SITE SHALL PROPERLY STORED SUCH THAT IT IS PROTECTED FROM DAMAGE AND EXPOSURE.

54. THE FINAL ACCEPTANCE WILL BE MADE AFTER THE CONTRACTOR HAS ADJUSTED HIS EQU TESTED THE VARIOUS SYSTEMS, DEMONSTRATED THAT IT FULFILLS THE REQUIREMENTS OF THE DRAWINGS AND SPECIFICATIONS, HAS FURNISHED ALL THE REQUIRED CERTIFICATIONS OF INSPECTION AND APPROVAL, AND SUBMITTED ALL THE NECESSARY CLOSE-OUT DOCUMENTS.

55. UPON COMPLETION AND ACCEPTANCE OF WORK, CONTRACTOR SHALL FURNISH WRITTEN INSTRUCTIONS AND EQUIPMENT MANUALS AND DEMONSTRATE TO THE OWNER THE PROPER OPERATION AND MAINTENANCE OF ALL EQUIPMENT AND APPARATUS FURNISHED UNDER THIS CONTRACT. THESE INSTRUCTIONS SHALL BE TYPED ON 8-1/2 IN. X 11 IN. PAPER AND BOUND IN THREE RING BINDERS WITH CLEAR ACETATE COVERS. CONTRACTOR SHALL GIVE THREE COPIES OF THE INSTRUCTIONS TO THE OWNER AND ONE COPY TO THE ENGINEER. THE INSTRUCTION BOOKLET SHALL BEAR THE NAME, ADDRESS, AND TELEPHONE NUMBER OF THE GENERAL CONTRACTOR, PLUMBING CONTRACTOR, ARCHITECT, AND ENGINEER. REPRODUCIBLE "AS-BUILT" DRAWINGS SHALL BE PROVIDED INDICATING THE AS INSTALLED CONDITIONS OF THE WORK. "AS-BUILT" DRAWINGS SHALL BE PROVIDED TO THE ARCHITECT AFTER COMPLETION OF THE INSTALLATION.

56. ALL VALVES AND SPECIALTY ITEMS MAY NOT BE SHOWN IN EVERY INSTANCE ON THE DRAWINGS, BUT ARE TO BE PROVIDED WHETHER SHOWN OR NOT WHEN NECESSARY FOR PROPER OPERATION AND

MAINTENANCE OF THE SYSTEM. UNLESS OTHERWISE NOTED, VALVES AND SPECIALTY ITEMS ARE TO BE RATED AT 125 PSIG. DEVICES

LARGER ARE TO HAVE FLANGED CONNECTIONS.

REFER TO SPECIFICATIONS FOR APPROVED VALVE MANUFACTURERS. 57. CONCEAL ALL PIPING IN BUILDING CONSTRUCTION OR UNDERGROUND. INSTALL SUCH PIPING IN

TIME SO AS NOT TO CAUSE DELAY TO WORK OF OTHER TRADES AND TO ALLOW AMPLE TIME FOR TESTS AND APPROVAL; DO NOT COVER BEFORE APPROVAL IS OBTAINED.

58. KEEP FIXTURE BRANCHES CONCEALED TO POINTS ABOVE FLOOR CLOSE TO FIXTURES; EXPOSE ONLY AS MUCH AS NECESSARY FOR FINAL CONNECTIONS.

59. WHERE FURRED SPACES ARE INDICATED, KEEP PIPES AS CLOSE TO STRUCTURAL MEMBERS AS POSSIBLE SO AS TO REQUIRE MINIMUM FURRINGS.

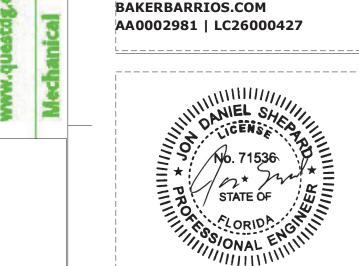
60. THE PLUMBING CONTRACTOR SHALL PROVIDE ESCUTCHEONS AT EACH POINT WHERE AN

UNINSULATED PIPE, CONDUIT, OR TUBING PASSES THROUGH A FINISHED SURFACE. ESCUTCHEONS WILL NOT GENERALLY BE REQUIRED FOR INSULATED PIPE AND CONDUIT OR TUBING PASSING THROUGH EOUIPMENT ROOM WALLS UNLESS, IN THE OPINION OF THE ENGINEER, THE INSTALLATION 45. SANITARY WASTE, VENT AND STORM PIPING SHALL BE SERVICE WEIGHT CAST IRON, NO-HUB WITH OF SUCH PIPE, CONDUIT, OR TUBING HAS NOT BEEN INSTALLED IN A NEAT AND ACCEPTABLE. ESCUTCHEONS SHALL BE CONSTRUCTED OF CHROME -PLATED BRASS UNLESS SPECIFICALLY APPROVED OTHERWISE BY THE ARCHITECT. EACH ESCUTCHEON SHALL FIT FLUSH WITH THE WALL OR FLOOR AND



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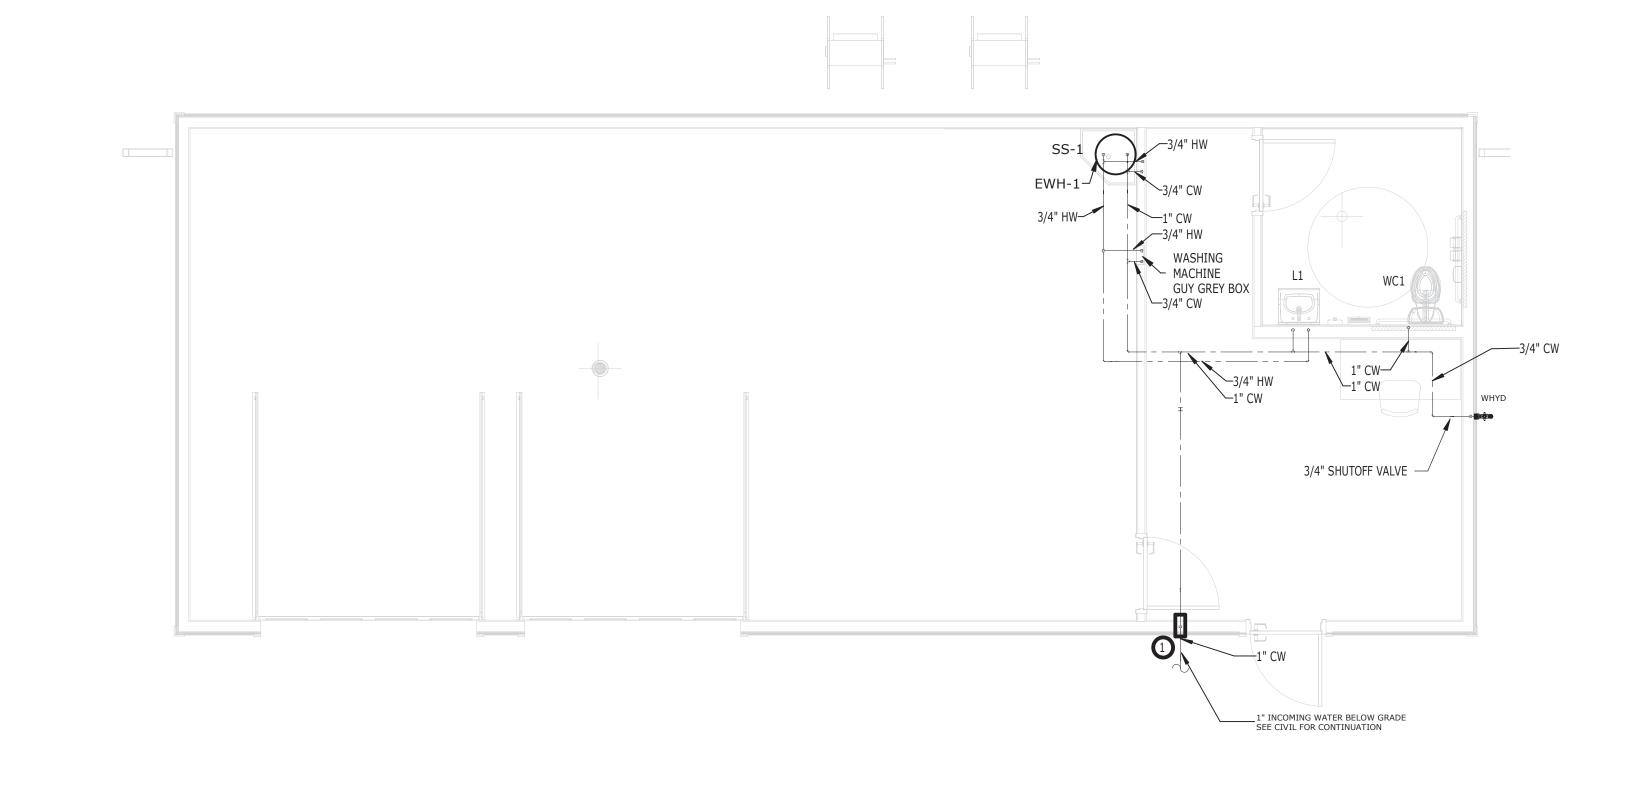
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220035.00

PLUMBING NOTES

RP7.00

L HENCHE SERBER ON SURF AND SU



2 MAINTENANCE BUILDING - DOMESTIC WATER PLAN 1/4" = 1'-0"

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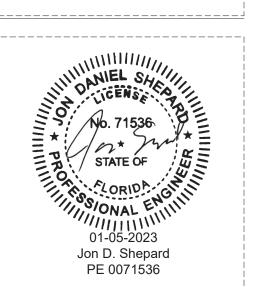
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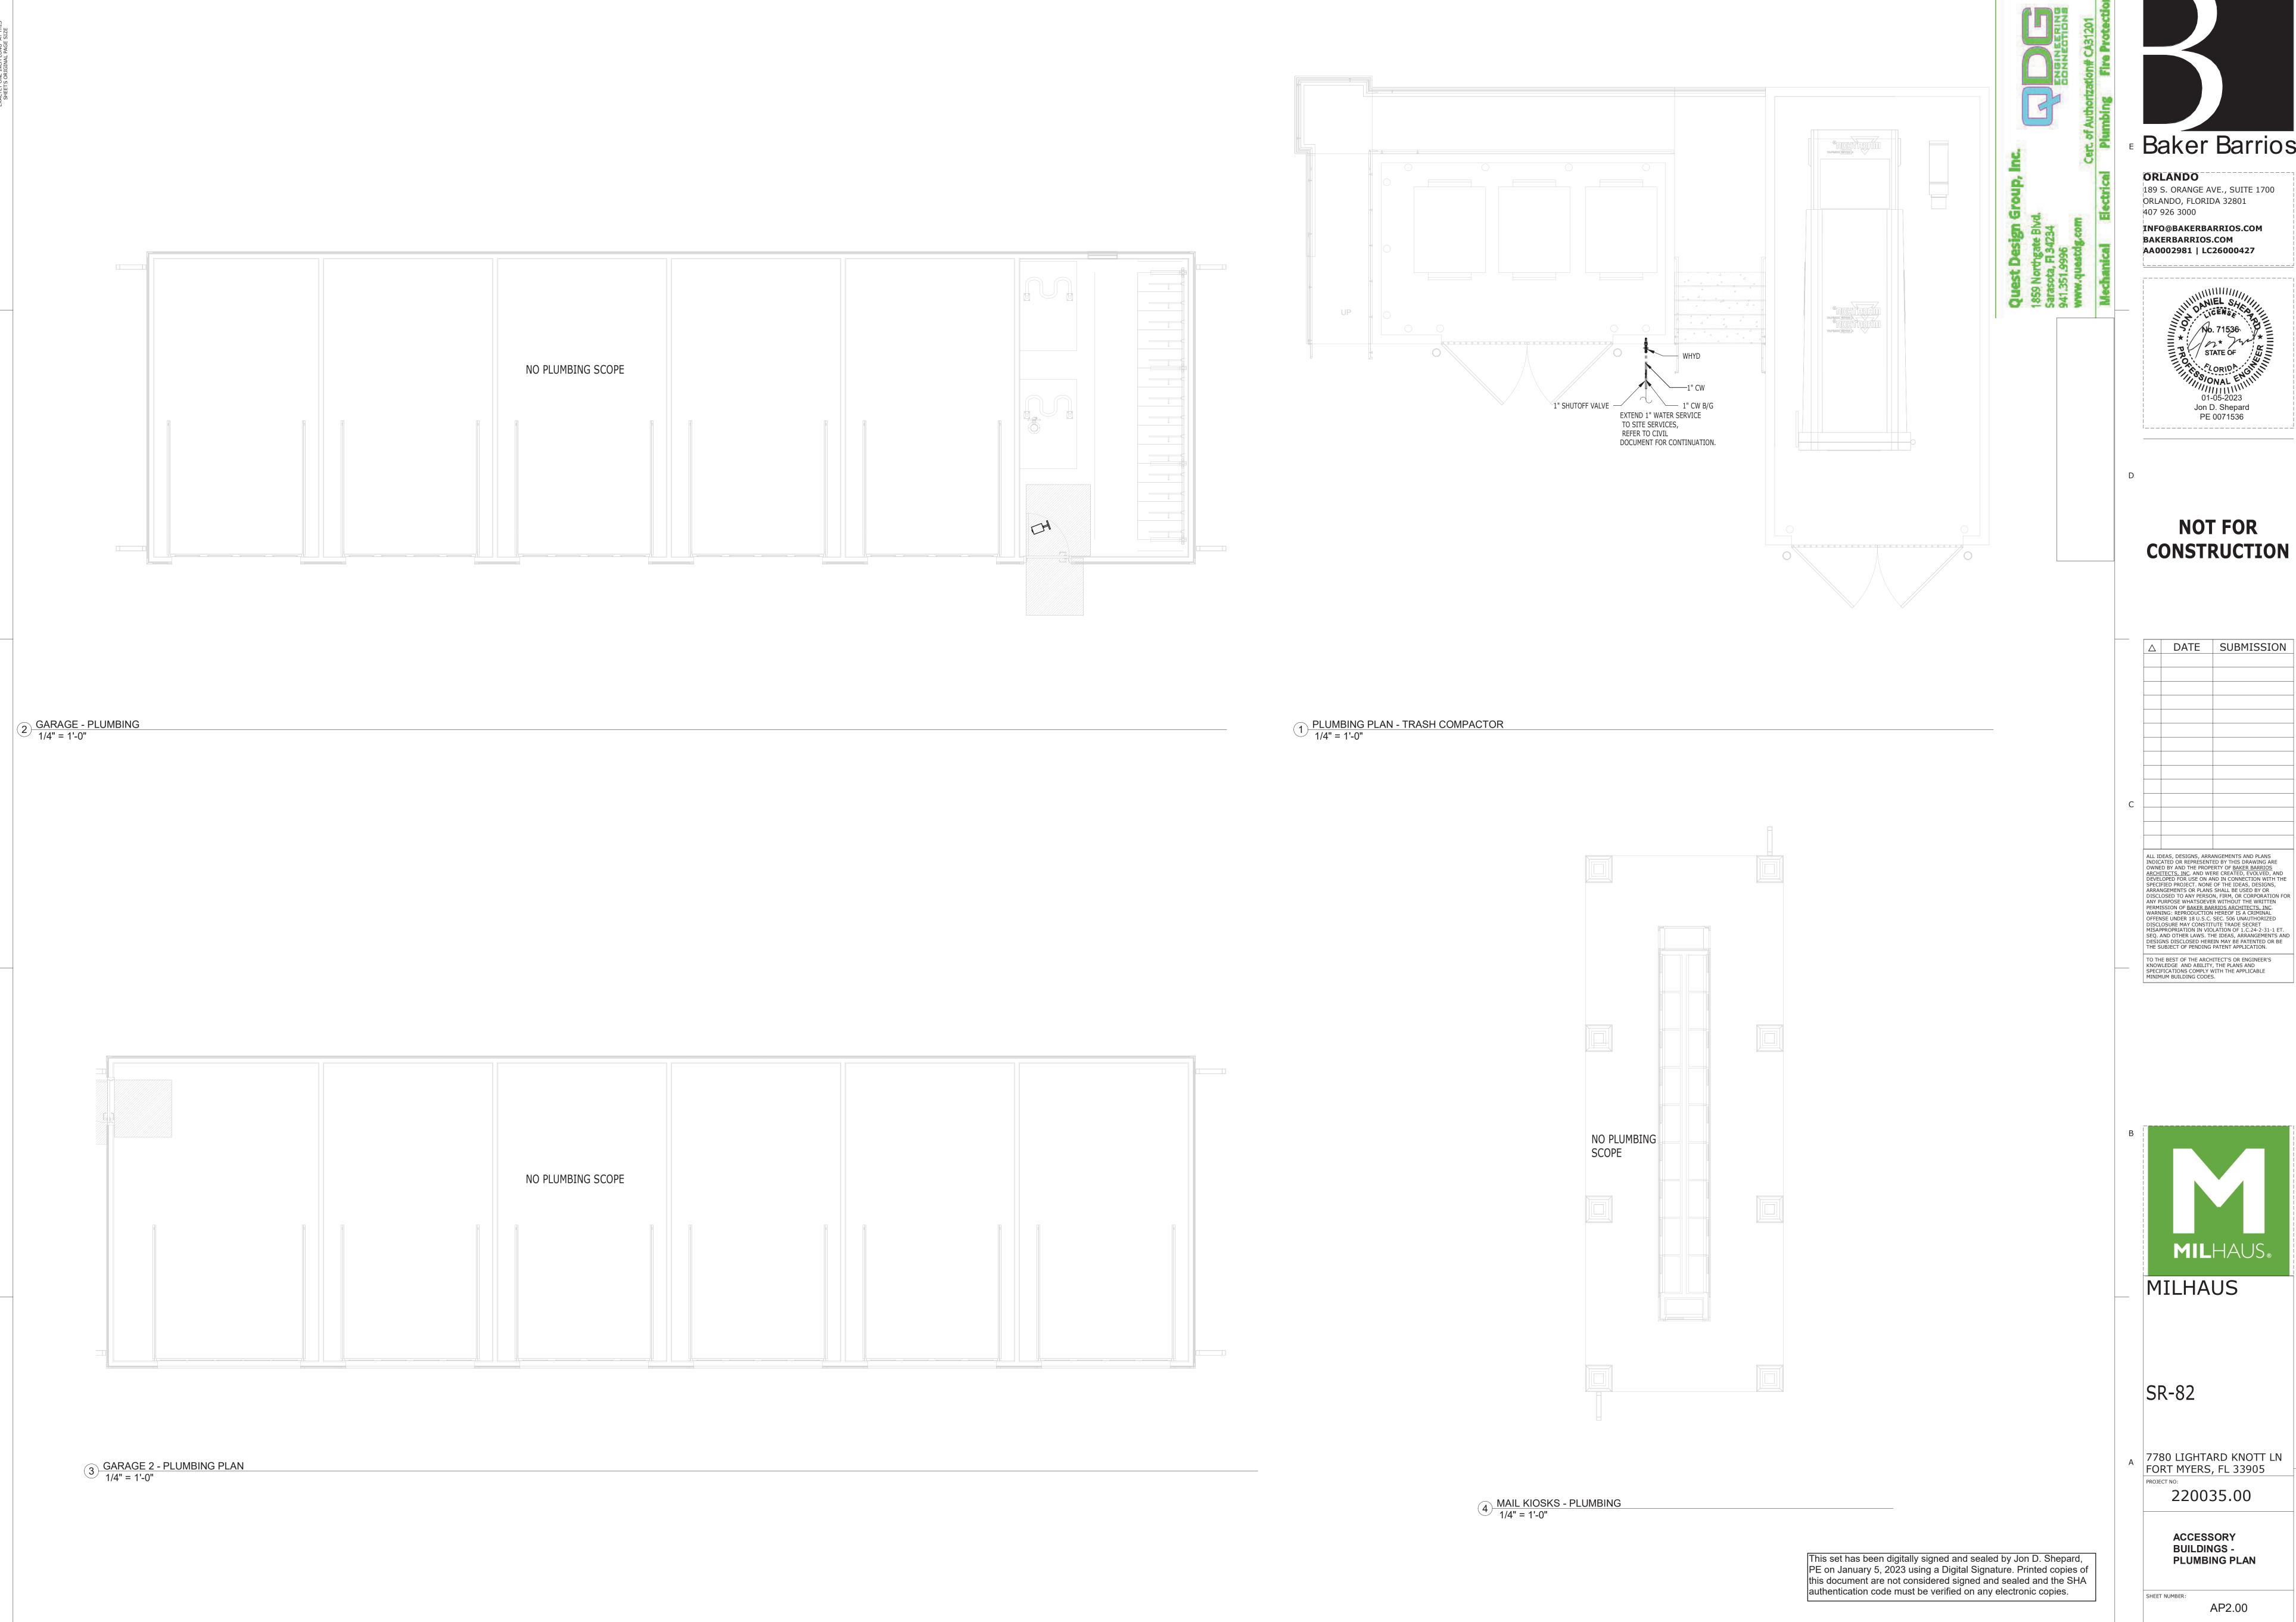
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MAINTENANCE BULDING -PLUMBING PLAN

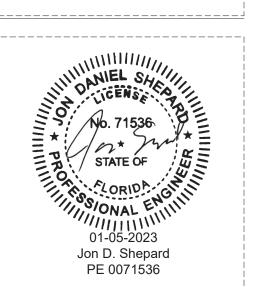
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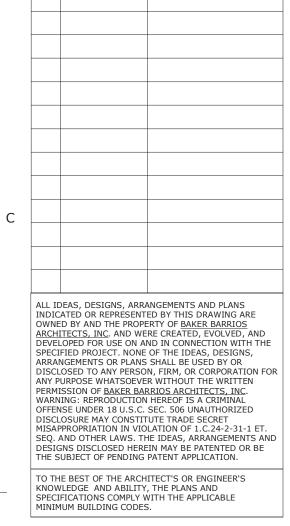


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ACCESSORY BUILDINGS -PLUMBING PLAN

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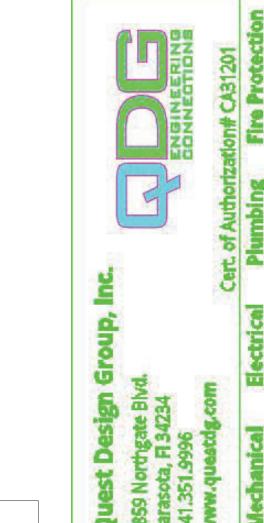
PLUMBING LEGENDS

FIXTURE WC1 SH1

<u>WC</u>O

2" VTR

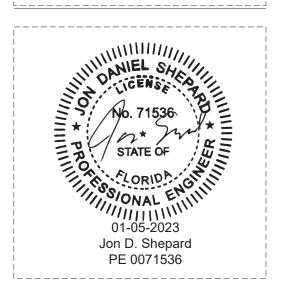
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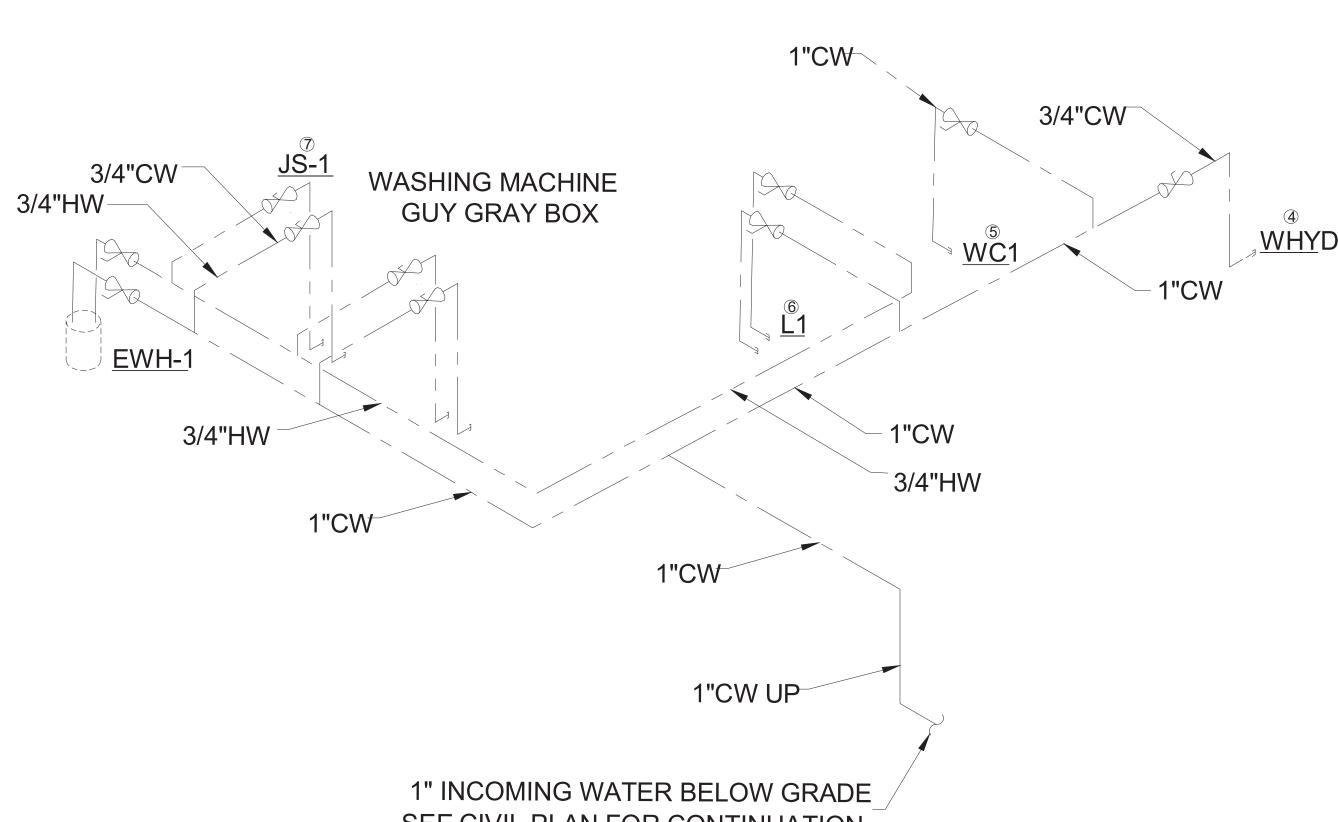
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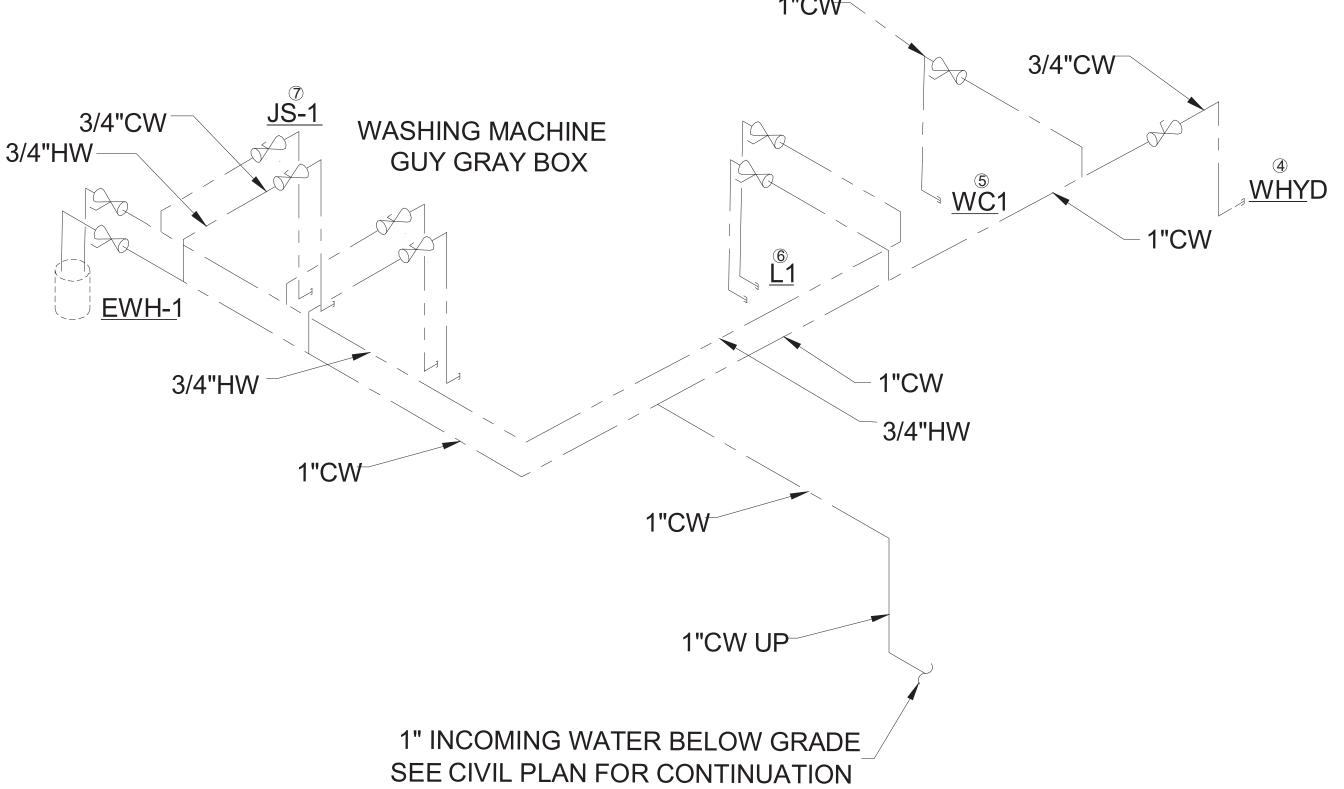
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PLUMBING RISERS

AP3.00

PLUMBING LEGENDS HWSFU FIXTURE CWSFU NOTE WC1 1.5 -







WASHING

MACHINE GUY
GREY BOX

2" VTR

FCO

1 WATER RISERS

N.T.S



				F	LUMBING FIXT	URE SCHEDULE ACC	ESSC	DRY									
			FIX	TURE TYPE			FIXTURE CONNECTION						FIXTURE UNITS				
TAG	QUANTITY	DESCRIPTION	TYPE	VALVE FAUCET	MATERIAL	REMARKS		WASTE		DOMESTIC		COLD	НОТ	TOTAL SUPPLY	SANITARY		
WC1	1	AMERICAN STANDARD MODEL #2467.016 "CADET" RIGHT- HEIGHT ELONGATED PRESSURE- ASSISTED	1	- VITREOUS CHINA	VITREOUS CHINA	Fixture performance and specifications meet or exceed ASME A112.19.2-2008/CSA B45.1-08 standards, and other state and local codes. UNIT TO BE PROVIDED WITH LAVATORY CARRIER	3"	3"	- 2"	1"	НОТ	WATER 5	WATER 0	5	4		
<u>L1</u>	1	LAVATORY	American Standard Lucerne 0355012PL020-1/ 2" Wall Mounted Porcelain Bathroom Sink	Manual Sink Faucets - 802-317XKA CP	VITDEOUS CHIMA	ASSEMBLY, OFF-SET GRID STRAINER ASSEMBLY WITH CHROME TAILPIECE AND CHROME P-TRAP ASSEMBLY, LOOSE KEY STOPS, ESCUTHEONS, ETC. UNIT TO BE PROVIDED WITH		1-1/2"	- 2"	3/4"	3/4"	1.5	1.5	2	2		
<u>JS1</u>	2	MOP SINK	MSB2424 - 24" X 24" Molded Stone Mop Service Basin	Service-Sinl - Faucet Model: 830-A	STAINLESS STEEL	"TRUEBRO" VINYL PIPE INSULATION KIT. Tiling flanges are optional, made of stainless steel, and extend 1" above the shoulder on 1, 2, or 3 sides, as required.	3"	3"	- 2"	3/4"	3/4"	3	3	4.5	6		
<u>FD</u>	3	FLOOR DRAIN	-		-	FLOOR DRAIN TO BE PROVIDED IN ALL COMMON BATHROOM AREAS,INCLUDING SINGLE USER COMMON BATHROOMS.	3"	3"		-	-	-	-	-	4		
WHYD	2	WHYD	-		-		-	-		-	-	-	-		-		

NOTES:

INSTALL BACKING AND SUPPORTS AS REQUIRED FOR ALL FIXTURES AND ACCESSORIES.

ALL FIXTURES SHALL MEET ADA AND LOCAL CODES

SUPPLY PIPING AND FITTING FOR ALL FIXTURES SHALL BE INSTALLED SO AS TO PREVENT BACKFLOW

ALL FIXTURES SHALL BE PROVIDED WITH ACCESSIBLE SHUT OFF VALVES AT COLD AND HOT WATER PIPING CONNECTIONS PROVIDE INSULATION FOR ALL PIPING IN EXTERIOR WALLS.

ALL PLUMBING FIXTURES SHALL BE COORDINATED AND APPROVED BY ARCHITECT PRIOR TO PURCHASE.

HOT WATER TO ALL LAVATORIES AND HAND SINKS SHALL NOT EXCEED 110 DEGREES.

COORDINATE ADA HEIGHT REQUIREMENTS WITH ARCHITECT DRAWINGS.

ALL HAND SINKS SHALL BE PROVIDED WITH APPROVED AUTOMATIC SAFETY WATER MIXING DEVICE AND PRESSURE BALANCE

A 1 1/4" PIPE.

9 DRAINAGE FIXTURE UNITS FOR THE SPACE WHICH REQUIRES NO LESS THAN 6" PIPE.

6 SUPPLY FIXTURE UNITS FOR SPACE WHICH IS

EQUAL TO 9.2 GPM AND REQUIRES NO LESS THAN

				GE	NERAL							ELE	CTRICAL		
QUIPMENT	LOCATION	MANUFACTURER	MODEL	UNIT TYPE	CAPACITY	WEIGHT (LBS.)	DIME	DIMENSIONS (INCHES)				МОСР	PHASE	VOLTS	NOTES
TAG	LOCATION	WANUFACIURER	WODEL	UNITITE	(GALLONS) WEIGHT (EBS.) DIAMETER WIDTH DEPTH		DEPTH	HEIGHT	IVICA	IVIOCP	PHASE	VOLIS			
EWH-1	SEE PLAN	AO SMITH	ENLB-40	TANK TYPE	38	118	23"	23"	23"	32"	4.4	15.0	1.0	240.0	2,3,4
NOTES	HEATER PER APA 2. PROVIDE ONE 3.ACCEPTABLE E 4. IF WATER HEA MANUFACTURER	ARTMENT UNIT. WATER HEATER PER QUAL MANUFACTURI TER IS SUPPLIED WIT MUST BE REPLACED	R APARTMENT L ERS ARE A.O.SI IH AN INSULAT WITH AN INSU	INIT. MITH, BRADFOR ON BLANKET TO LATION BL	D WHITE, LOCKI MEET THE REC	INATE ELECTRICAL REQUIR NVAR, PVI, RHEEM OR STA QUIRED ENERGY FACTOR, 1	E HE BLANKET MUS	ST BE PLE	NUM RAT	ΓED. NON-	-PLENI	JM RATE	ED BLANK	ETS SUPPLI	IED BY THE



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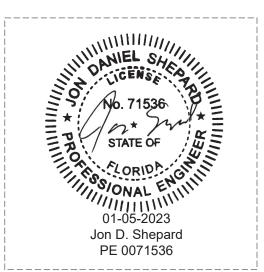
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INDIC OWNE ARCHI DEVEL SPECI ARRAI DISCL ANY P PERMI WARN OFFEN DISCL MISAF SEQ. / DESIG	ATED OR REPRÉSENT ID BY AND THE PROPE IDENTIFICATION. AND WE COPED FOR USE ON A FIED PROJECT. NONE NOGEMENTS OR PLANS OSED TO ANY PERSOURPOSE WHATSOEVE ISSION OF BAKER BAI ISING: REPRODUCTION ISE UNDER 18 U.S.C. OSURE MAY CONSTIT PROPRIATION IN VIO AND OTHER LAWS. THE ISMS DISCLOSED HERE	ED BY THIS DRAWING ARE IRTY OF BAKER BARRIOS RE CREATED, EVOLVED, AND ND IN CONNECTION WITH THE OF THE IDEAS, DESIGNS, SHALL BE USED BY OR N, FIRM, OR CORPORATION FOR R WITHOUT THE WRITTEN RRIOS ARCHITECTS, INC. HEREOF IS A CRIMINAL SEC. 506 UNAUTHORIZED UTE TRADE SECRET LATION OF 1.C.24-2-31-1 ET. HE IDEAS, ARRANGEMENTS AND IN MAY BE PATENTED OR BE
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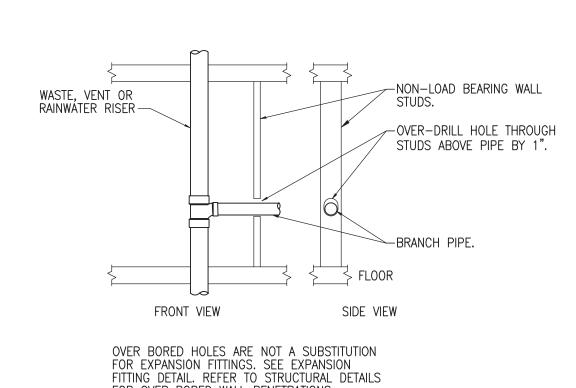
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PLUMBING SCHEDULES


1BER:
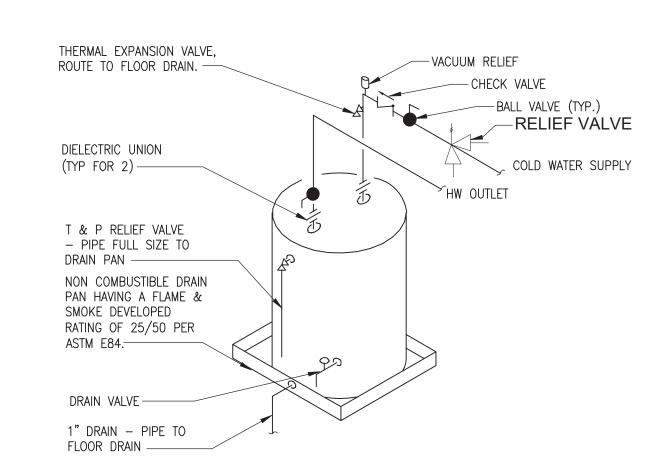
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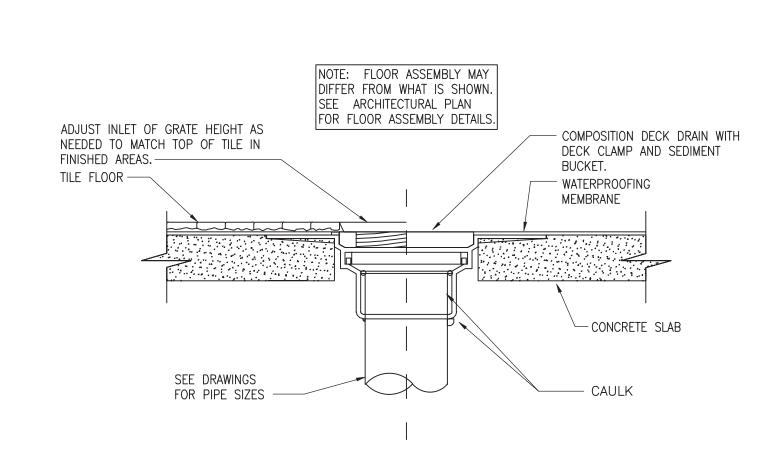
1 PIPE WALL STUD PENETRATION DETAIL NO SCALE

FOR OVER BORED WALL PENETRATIONS.

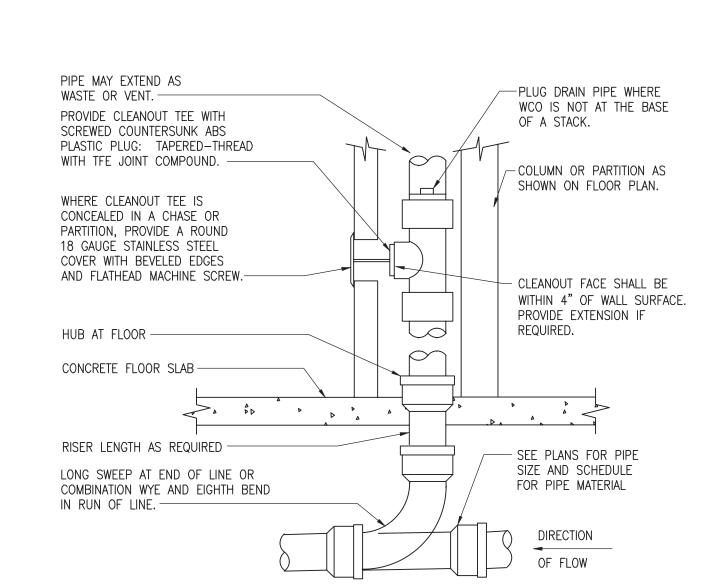


- 1. COORDINATE PIPING WITH MECHANICAL UNIT ABOVE. PIPING AND WATER HEATER CANNOT BE GREATER THAN 42" AFF. 2. DRAIN PAN AND ALL PRODUCTS IN THE APARTMENT MECHANICAL CLOSETS SHALL
- BE NON-COMBUSTIBLE AND MEET THE 25/50 FLAME/SMOKE DEVELOPED RATING PER ASTM E-84. 3. PVC PIPE IS NOT ALLOWED IN THE MECHANICAL CLOSETS.
- 4. WATER HEATER SHALL BE INSTALLED TO BE EASILY ACCESSIBLE FOR MAINTENANCE AND REPLACEMENT.
- 5. SEE HVAC DRAWINGS FOR PLACEMENT OF WH IN RELATION TO FCU. 6. HEAT TRAPS OR HEAT TRAP NIPPLES ARE REQUIRED ON ALL WATER HEATERS. 7. THE FIRST 8 FEET OF OUTLET PIPING SHALL BE INSULATED PER ASHRAE 90.1-2010 SECTION 7.4.3.

5 WATER HEATER DETAIL
NO SCALE





2 FLOOR DRAIN DETAIL NO SCALE




PROVIDE WCO AT BASE OF ALL WASTE STACKS AND RAIN-LEADER DOWNSPOUTS. PROVIDE WCO WHERE SHOWN ON PLAN, AND ON SANITARY WASTE BRANCHES NOT SERVED WITH A FLOOR CLEANOUT. LOCATE ABOVE FIXTURE FLOOD RIM WITHIN 4' OF FLOOR. CONSULT LOCAL CODES FOR OTHER WCO REQUIREMENTS.

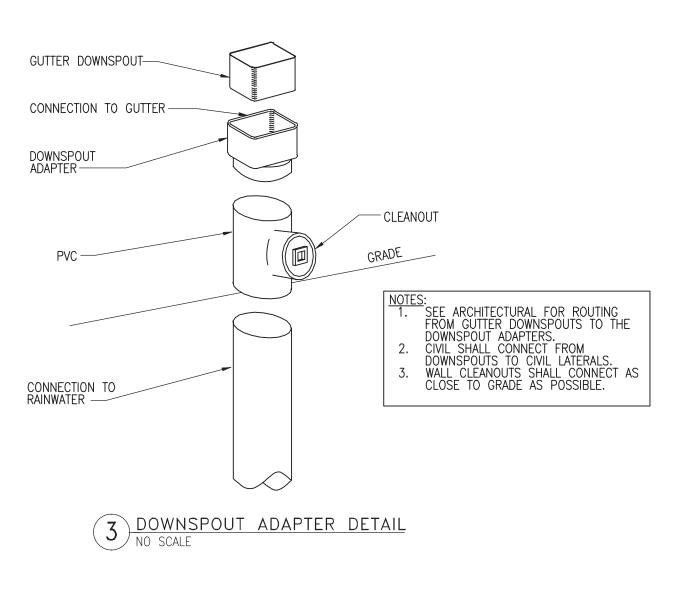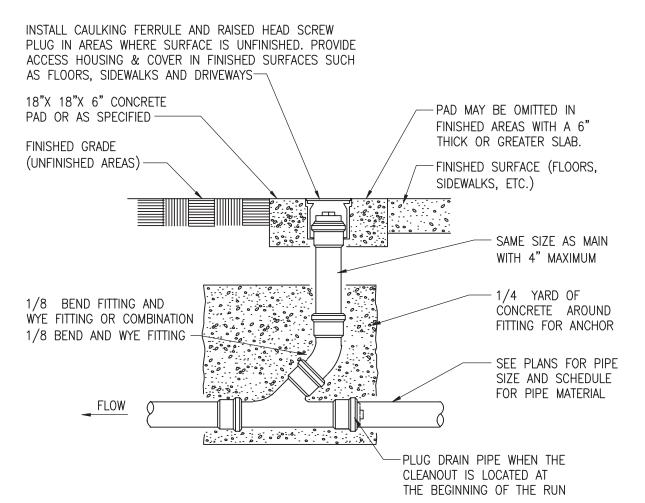6 WALL CLEANOUT DETAIL
NO SCALE






7 FLOOR/GRADE CLEANOUT DETAIL
NO SCALE

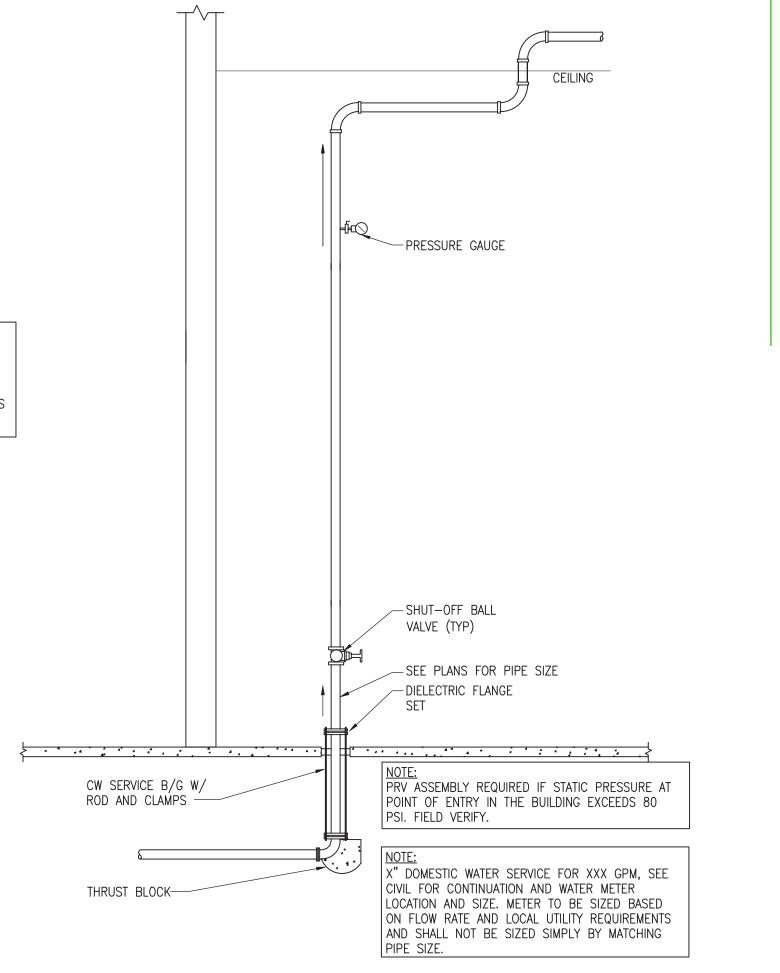


4 DOMESTIC WATER SERVICE ENTRY NO SCALE
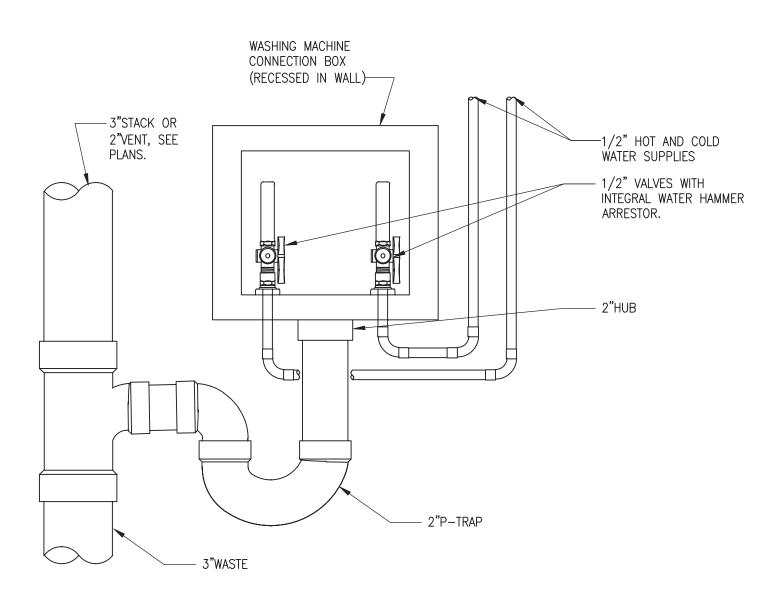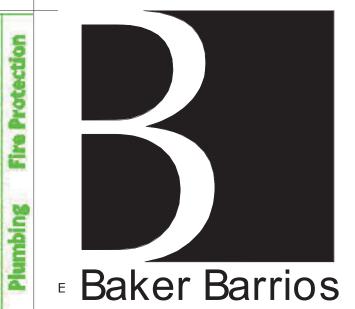
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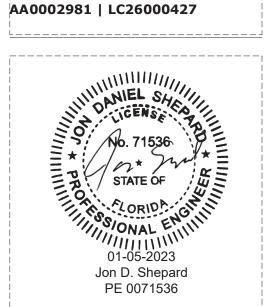
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8 WASHING MACHINE BOX DETAIL NO SCALE PROVIDE FIRE RATED WMB WHEN INSTALLED ON A FIRE RATED WALL. SEE ARCHITECTURAL WALL TYPES.



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AP5.00

PLUMBING GENERAL NOTES:

1. DRAWINGS ARE DIAGRAMMATIC AND INDICATE THE GENERAL ARRANGEMENT OF SYSTEMS AND WORK INCLUDED IN THE CONTRACT. DRAWINGS ARE NOT TO BE SCALED. THE ARCHITECTURAL DRAWINGS AND DETAILS SHALL BE EXAMINED FOR EXACT LOCATION OF FIXTURES AND EQUIPMENT. SYSTEMS SHALL INCLUDE ALL APPURTENANCES AS REQUIRED TO ACHIEVE THE OPERATING CONDITIONS AS SHOWN AND SPECIFIED AND SHALL RESULT IN A SUPERIOR INSTALLATION. INFORMATION CONTAINED ON THE DRAWINGS BUT NOT IN THE SPECIFICATIONS OR IN THE SPECIFICATIONS BUT NOT ON THE DRAWINGS ARE INTENDED TO BE IN BOTH. MINOR DETAILS NOT USUALLY SHOWN OR SPECIFIED BUT NECESSARY FOR PROPER OPERATION AND CONSISTENT WITH GOOD WORKMANSHIP WILL BE INCLUDED IN THE ESTIMATE, THE SAME AS IF SHOWN ON THE DRAWINGS. ANY CONFLICT SHALL BE IMMEDIATELY BROUGHT TO THE ATTENTION OF THE ARCHITECT OR ENGINEER BEFORE PROCEEDING WITH THE WORK.

2. THE PLUMBING CONTRACTOR SHALL FURNISH ALL EQUIPMENT, MATERIAL, LABOR, ETC. NECESSARY TO PROVIDE A COMPLETE, WORKABLE AND CODE APPROVED PLUMBING SYSTEM. ALL WORK SHALL BE DONE IN ACCORDANCE WITH THESE PLANS AND SPECIFICATIONS, LOCAL, STATE AND NATIONAL

3. THE PLUMBING CONTRACTOR SHALL GIVE ALL NECESSARY NOTICES, OBTAIN ALL PERMITS AND PAY ALL GOVERNMENT FEES, SALES TAXES AND OTHER COSTS IN CONNECTION WITH HIS WORK; FILE ALL NECESSARY APPROVALS OF ALL GOVERNMENTAL DEPARTMENTS HAVING JURISDICTION: OBTAIN ALL REQUIRED CERTIFICATES OF INSPECTION FOR HIS WORK; AND DELIVER TO THE ARCHITECT THE SAME CERTIFICATES BEFORE REQUEST FOR ACCEPTANCE AND FINAL PAYMENT FOR THE WORK.

4. ALL WORK SHALL BE GUARANTEED, BOTH MATERIAL AND INSTALLATION, FOR A PERIOD OF ONE

5. FURNISH SIX (6) COPIES OF SHOP DRAWINGS OF EQUIPMENT OR FIXTURES FOR APPROVAL PRIOR TO PURCHASING.

6. CONTRACTOR SHALL KEEP A RECORD OF THE LOCATIONS OF ALL CONCEALED WORK AND UPON COMPLETION OF THE JOB, SHALL SUPPLY ACAD QUALITY AS-BUILT DRAWINGS SHOWING ANY DEVIATION FROM THE ORIGINAL DRAWINGS. THESE DRAWINGS SHALL INDICATE DIMENSIONS OF BURIED UTILITY LINES FROM BUILDING WALLS.

7. THE PLUMBING CONTRACTOR SHALL COORDINATE WITH ALL TRADES FOR PIPE ROUTING AND INSTALLATION OF EQUIPMENT AND SYSTEMS TO PROVIDE FOR REQUIRED CLEARANCES.

8. ALL OPENINGS THROUGH FIRE RATED WALLS OR FLOORS SHALL BE SEALED WITH A U.L. LISTED PENETRATION AND SHALL MAINTAIN THE FIRE RATED INTEGRITY OF THE WALL OR FLOOR. THE CONTRACTOR SHALL VERIFY FIRE RATINGS WITH ARCHITECTURAL DRAWINGS PRIOR TO INSTALLATION.

9. PIPE PASSING THROUGH PIT WALLS, BUILDING WALLS, AND BUILDING FLOORS BELOW GRADE SHALL BE PROVIDED WITH SLEEVES OF STANDARD WEIGHT GALVANIZED STEEL PIPE. THE ANNULAR SPACES BETWEEN PIPE AND SLEEVES SHALL BE SEALED WITH LINK SEAL HYDROSTATIC PIPE WALL SEAL. SLEEVES SHALL BE SIZED AS FOLLOWS:

3" PIPE - 6" ID SLEEVE 4" PIPE - 8" ID SLEEVE

6" PIPE - 10" ID SLEEVI 8" PIPE - 12" ID SLEEVE 10" PIPE - 12" ID SLEEVE

YEAR FROM ACCEPTANCE BY OWNER.

10. BREAKAGE AND CORROSION: PIPES PASSING UNDER OR THROUGH WALLS SHALL BE PROTECTED FROM BREAKAGE. PIPES PASSING THROUGH CONCRETE OR CINDER WALLS AND FLOORS OR OTHER CORROSIVE MATERIAL SHALL BE PROTECTED AGAINST EXTERNAL CORROSION BY A PROTECTIVE SHEATHING OR WRAPPING OR OTHER MEANS THAT WILL WITHSTAND ANY REACTION FROM LIME AND ACID OF CONCRETE, CINDER OR OTHER CORROSIVE MATERIAL. SHEATHING OR WRAPPING SHALL ALLOW FOR EXPANSION AND CONTRACTION OF PIPING TO PREVENT ANY RUBBING ACTION. MINIMUM WALL THICKNESS OF MATERIAL IS TO BE 0.025 INCH.

11. PROVIDE WALL CARRIERS FOR ALL WALL HUNG PLUMBING FIXTURES. ALL WALL HUNG PLUMBING FIXTURES SHALL BE CAPABLE OF SUPPORTING A 250 POUND VERTICAL LOAD.

12. THE PLUMBING CONTRACTOR SHALL VERIFY SIZE AND LOCATION OF ALL EXISTING SERVICES PRIOR TO COMMENCING WITH THE WORK.

13. CONTRACTOR SHALL EXTEND AS NECESSARY AND CONNECT BUILDING DRAIN AND POTABLE WATER LINES TO EXISTING SERVICE LINES AT LOCATION ON SITE OR IN BUILDING AS REQUIRED. VERIFY EXACT LOCATION AND INVERT ELEVATION OF SERVICE CONNECTIONS PRIOR TO CONSTRUCTION. (10) LINEAR FEET FROM THE BUILDING.

14. OFFER REMOVED MATERIAL TO THE OWNER. REMOVE ALL MATERIAL REJECTED BY THE OWNER FROM THE WORK SITE AND DISPOSE OF IN ACCORDANCE WITH APPLICABLE LOCAL, STATE AND NATIONAL CODES. CONTRACTOR MUST CERTIFY TO OWNER THAT THE MATERIAL HAS BEEN LEGALLY

POTABLE WATER PIPING:

15. BELOW GROUND WATER PIPING SHALL BE TYPE "K" COPPER WITH VINYL SLEEVE FOR CORROSION PROTECTION WITH WROUGHT COPPER FITTINGS AND 95-5 SOLDERED JOINTS.

16. ABOVE GROUND WATER PIPING SHALL BE TYPE "L" COPPER WITH WROUGHT COPPER FITTINGS AND 95-5 SOLDERED JOINTS.

17. INTERIOR ABOVE AND BELOW GROUND WATER PIPING SHALL BE (CPVC) CHLORINATE POLYVINYL CHLORIDE PLASTIC PIPE AND TUBING (ASTM D-2846) FLOWGUARD OR EQUIVALENT WITH APPROVED CPVC SOLVENT WELDED FITTINGS. CPVC WATER PIPING SHALL NOT BE RUN IN RETURN AIR PLENUM OR FIRE RATED ASSEMBLIES UNLESS ALLOWED BY LOCAL JURISDICTION.

17a. INTERIOR ABOVE AND BELOW GROUND WATER PIPING SHALL BE CROSSLINKED POLYETHYLENE (PEX-a) STRAIGHT, COILED AND EXPANSION LOOPED PIPE AND TUBING (ASTM F876 AND F877) UPONOR AQUAPEX WHITE OR EQUIVALENT WITH COLD-EXPANSION FITTINGS (ASTM F877 AND F1960), LEAD FREE DEZINCIFICATION RESISTAND BRASS COUPLINGS, FITTINGS AND VALVES (ASTM F877 AND F1960) FOR ABOVE AND UNDERGROUND INSTALLATIONS AND/OR ENGINEERED POLYMER (ASTM F877 AND F1960) FOR ABOVE GROUND INSTALLATIONS. PEX-a WATER PIPING SHALL NOT BE RUN IN RETURN AIR PLENUM UNLESS INSTALLED PER MANUFACTURER'S WRITTEN INSTRUCTIONS FOR RETURN AIR PLENUM INSTALLATION AND APPROVED BY LOCAL JURISDICTION. PEX MANUFACTURE SHALL PROVIDE SHOP DRAWINGS INDICATING THE SYSTEM(S) HAVE BEEN ANALYZED FOR USE OF PEX PIPING FOR THIS APPLICATION.

18. EXTERIOR BUILDING SERVICE SHALL BE SCHEDULE 40 PVC (ASTM D-1785) WITH APPROVED PVC SOLVENT WELDED FITTINGS.

19. INTERIOR ABOVE AND BELOW GRADE HIGH TEMPERATURE HOT WATER (140°F OR GREATER) PIPING SHALL BE TYPE "L" HARD DRAWN COPPER TUBE WITH COPPER FITTINGS AND 95-5 SOLDERED JOINTS.

20. THE SITE SUBCONTRACTOR SHALL PROVIDE THE BACKFLOW PREVENTOR AND THE WATER METER. 21. A SERVICE VALVE SHALL BE PROVIDED ON THE DOMESTIC WATER RISER AT 5'-0" ABOVE FINISHED FLOOR, WHERE WATER ENTERS THE BUILDING.

22. PROVIDE WATER HAMMER ARRESTORS ON HOT AND COLD WATER LINES ON ALL QUICK CLOSING DEVICES PER CHAPTER 6 OF FLORIDA BUILDING CODE PLUMBING.

23. PROVIDE VACUUM BREAKERS AS REQUIRED BY CODE.

24. TEST ALL WATER PIPING AT 100 PSIG FOR TWENTY-FOUR (24) HOURS OR AS REQUIRED BY CODE.

25. STERILIZE ALL WATER PIPING IN ACCORDANCE WITH HEALTH DEPARTMENT REGULATIONS AND AMERICAN WATER WORKS SPECIFICATIONS.

26. SUPPORT ALL WATER PIPING WITH PIPE HANGERS BY GRINNELL OR EQUAL.

27. PROVIDE RISER CLAMPS AT EACH FLOOR FOR ALL VERTICAL PIPING INCLUDING SANITARY DRAINS, VENTS, AND WATER LINES. INSTALL RISERS SO AS TO ALLOW VERTICAL MOVEMENT OF PIPING, ANCHORING PIPES AT THE BASE OF ALL RISERS.

28. PROVIDE ACCESS DOORS WHERE NECESSARY TO SERVICE SEALS, VALVES, TRAPS, CLEAN-OUTS, AIR CHAMBERS/WATER HAMMER ARRESTORS, ETC. ALL ACCESS DOORS IN TOILET ROOMS SHALL BE STAINLESS STEEL.

29. PROVIDE DIELECTRIC UNIONS OR FITTINGS WHENEVER FERROUS AND NON-FERROUS PIPES ARE JOINED.

30. INSULATE HOT WATER PIPING WITH 1 INCH ARMSTRONG AP ARMAFLEX UP TO AND INCLUDING 1 1/4-INCH DIAMETER. SECURE WITH ADHESIVE.

31. INSULATE HOT WATER PIPING OVER 1 1/4-INCH WITH 1 INCH THICK FIBERGLASS PIPE COVERING FINISHED WITH WHITE MASTIC. FITTINGS SHALL BE INSULATED WITH MITERED PIPE COVERING FINISHED WITH WHITE MASTIC OR PVC FITTING COVERS.

32. HANDICAPPED LAVATORIES: INSULATE WATER SUPPLIES AND WASTE PIPING REQUIRING ADA CONFORMANCE, WITH LAV-GUARD KITS, BY TRUEBRO OR EQUAL.

33. THIS SYSTEM WAS DESIGNED TO 50 PSI STATIC PRESSURE WITH RESIDUAL PRESSURE OF 20 PSI AT 1000 GPM FROM THE NEAREST FIRE HYDRANT. THESE CONDITIONS SHALL BE VERIFIED BY THE PLUMBING CONTRACTOR PRIOR TO PROCEEDING WITH THE INSTALLATION. NOTIFY THE ENGINEER IMMEDIATELY IF FLOW AND PRESSURES OBTAINED ARE BELOW THOSE CONTAINED IN THIS

34. WATER HEATERS: WATER HEATERS MUST BEAR ASHRAE LABEL INDICATING COMPLIANCE WITH ASHRAE STANDARD 90 OR COMPLY WITH EFFICIENCY AND STANDBY LOSS REOUIREMENTS. SWITCH OR CLEARLY MARKED CIRCUIT BREAKER (ELECTRIC) OR CUT-OFF (GAS) MUST BE PROVIDED. HEAT TRAPS REQUIRED. MUST MEET MINIMUM WATER HEATING EQUIPMENT EFFICIENCIES AS ESTABLISHED BY THE FLORIDA MODEL ENERGY CODE.

SANITARY WASTE, VENT AND STORM PIPING

35. SANITARY WASTE AND VENT PIPING SHALL BE SCHEDULE 40 PVC (ASTM D-2665) WITH APPROVED PVC SOLVENT WELDED FITTINGS. COMPLY WITH 2020 FLORIDA BUILDING CODE. PVC PIPING SHALL NOT BE RUN IN RETURN AIR PLENUM OR FIRE RATED ASSEMBLIES.

36. SANITARY WASTE AND VENT PIPING SHALL BE SERVICE WEIGHT CAST IRON, NO-HUB WITH STAINLESS STEEL CLAMPS AND SHIELDS WITH NEOPRENE SEALING SLEEVES.

37. ALL SOIL AND WASTE PIPING, 2-1/2" AND SMALLER, SHALL BE SLOPED AT 1/4" PER FOOT. LARGER WASTE PIPING SHALL BE SLOPED AT 1/8" PER FOOT. 38. TEST SANITARY WASTE AND VENT PIPING BY A 10' WATER COLUMN FOR TWENTY-FOUR (24) HOURS

OR AS REQUIRED BY THE BUILDING DEPARTMENT. 39. ALL VENTS THROUGH ROOF SHALL BE A MINIMUM OF 10'-0" OR AS REQUIRED BY CODE AWAY FROM FRESH AIR INTAKES.

40. ALL VENTS THROUGH ROOF SHALL BE PROVIDED WITH FOUR (4) POUND SHEET LEAD FLASHING EXTENDING UPWARD AROUND THE PIPE AND TURNED DOWN INSIDE THE PIPE.

41. FLOOR DRAINS TO HAVE 4-INCH DEEP SEAL TRAPS. EXACT DRAIN LOCATION SHALL BE COORDINATED WITH ARCHITECT PRIOR TO ROUGH IN.

42. FLOOR SINKS TO HAVE 4-INCH DEEP SEAL TRAPS. EXACT DRAIN LOCATION SHALL BE COORDINATED WITH ARCHITECT PRIOR TO ROUGH IN.

43. PROVIDE ASSE 1072 CERTIFIED TRAP SEAL BARRIERS FOR ALL FLOOR DRAINS AND HUB DRAINS THAT ARE NOT CONTINUOUSLY WASHED BY AN APPLIANCE OR FIXTURE.

44. SANITARY WASTE, VENT AND STORM PIPING SHALL BE SCHEDULE 40 PVC (ASTM D-2665) WITH

APPROVED PVC SOLVENT WELDED FITTINGS. COMPLY WITH 2020, 7th EDITION FLORIDA BUILDING CODE. PVC PIPING SHALL NOT BE RUN IN RETURN AIR PLENUM OR FIRE RATED ASSEMBLIES. 45. SANITARY WASTE, VENT AND STORM PIPING SHALL BE SERVICE WEIGHT CAST IRON, NO-HUB WITH STAINLESS STEEL CLAMPS AND SHIELDS WITH NEOPRENE SEALING SLEEVES.

46. ALL SOIL AND WASTE PIPING, 2-1/2" AND SMALLER, SHALL BE SLOPED AT 1/4" PER FOOT. LARGER SHALL FIT SNUGLY AROUND THE PIPE. WASTE PIPING SHALL BE SLOPED AT 1/8" PER FOOT.

47. INSULATION FIT: INSULATION SHALL BE APPLIED TO PIPE AND EQUIPMENT WITH ALL JOINTS FITTED TO ELIMINATE VOIDS, VOIDS SHALL NOT BE FILLED WITH JOINT SEALANT, BUT SHALL BE ELIMINATED BY REFITTING OR REPLACING INSULATION.

CONTRACTOR SHALL NOTIFY ENGINEER IMMEDIATELY IF THE DISTANCE TO SITE SERVICES EXCEED TEN 48. ALL VENTS THROUGH ROOF SHALL BE A MINIMUM OF 10'-0" OR AS REQUIRED BY CODE AWAY FROM FRESH AIR INTAKES.

> 49. ALL VENTS THROUGH ROOF SHALL BE PROVIDED WITH FOUR (4) POUND SHEET LEAD FLASHING EXTENDING UPWARD AROUND THE PIPE AND TURNED DOWN INSIDE THE PIPE.

50. PROVIDE AND INSTALL SHUT OFF VALVES AND SECTIONAL VALVES AS REQUIRED BY APPLICABLE FLORIDA BUILDING CODES AND PLUMBING SPECIFICATION SECTIONS.

51. PIPE ROUTING IS SHOWN DIAGRAMMATICALLY AND DOES NOT SHOW ALL OFFSETS, DROPS, AND RISES OF RUNS. THE CONTRACTOR SHALL ALLOW IN HIS PRICE FOR ROUTING OF PIPE TO AVOID OBSTRUCTIONS. COORDINATION WITH UTILITY SERVICES, INCLUDING THOSE OF OTHER TRADES IS REQUIRED. MAINTAIN HEADROOM AND SPACE LOCATIONS.

52. INSTALL WORK AS TO BE READILY ACCESSIBLE FOR OPERATION, MAINTENANCE, AND REPAIR. MINOR DEVIATIONS FROM DRAWINGS MAY BE MADE TO ACCOMPLISH THIS, BUT CHANGES WHICH INVOLVE EXTRA COST SHALL NOT BE MADE WITHOUT APPROVAL.

53. ALL MATERIALS AND EQUIPMENT TO BE NEW UNLESS OTHERWISE NOTED AND SHALL BE IN ACCORDANCE WITH BUILDING STANDARDS. ALL MATERIALS AND EQUIPMENT ON SITE SHALL BE PROPERLY STORED SUCH THAT IT IS PROTECTED FROM DAMAGE AND EXPOSURE.

54. THE FINAL ACCEPTANCE WILL BE MADE AFTER THE CONTRACTOR HAS ADJUSTED HIS EOUIPMENT. TESTED THE VARIOUS SYSTEMS, DEMONSTRATED THAT IT FULFILLS THE REQUIREMENTS OF THE DRAWINGS AND SPECIFICATIONS, HAS FURNISHED ALL THE REQUIRED CERTIFICATIONS OF INSPECTION AND APPROVAL, AND SUBMITTED ALL THE NECESSARY CLOSE-OUT DOCUMENTS.

55. UPON COMPLETION AND ACCEPTANCE OF WORK, CONTRACTOR SHALL FURNISH WRITTEN INSTRUCTIONS AND EQUIPMENT MANUALS AND DEMONSTRATE TO THE OWNER THE PROPER OPERATION AND MAINTENANCE OF ALL EQUIPMENT AND APPARATUS FURNISHED UNDER THIS CONTRACT. THESE INSTRUCTIONS SHALL BE TYPED ON 8-1/2 IN. X 11 IN. PAPER AND BOUND IN THREE RING BINDERS WITH CLEAR ACETATE COVERS. CONTRACTOR SHALL GIVE THREE COPIES OF THE INSTRUCTIONS TO THE OWNER AND ONE COPY TO THE ENGINEER. THE INSTRUCTION BOOKLET SHALL BEAR THE NAME, ADDRESS, AND TELEPHONE NUMBER OF THE GENERAL CONTRACTOR, PLUMBING CONTRACTOR, ARCHITECT, AND ENGINEER. REPRODUCIBLE "AS-BUILT" DRAWINGS SHALL BE PROVIDED INDICATING THE AS INSTALLED CONDITIONS OF THE WORK, "AS-BUILT" DRAWINGS SHALL

56. ALL VALVES AND SPECIALTY ITEMS MAY NOT BE SHOWN IN EVERY INSTANCE ON THE DRAWINGS, BUT ARE TO BE PROVIDED WHETHER SHOWN OR NOT WHEN NECESSARY FOR PROPER OPERATION AND MAINTENANCE OF THE SYSTEM.

UNLESS OTHERWISE NOTED, VALVES AND SPECIALTY ITEMS ARE TO BE RATED AT 125 PSIG. DEVICES AND VALVES 2-1/2" AND SMALLER ARE TO HAVE SOLDERED OR SCREWED CONNECTION AND 3" AND LARGER ARE TO HAVE FLANGED CONNECTIONS.

REFER TO SPECIFICATIONS FOR APPROVED VALVE MANUFACTURERS.

BE PROVIDED TO THE ARCHITECT AFTER COMPLETION OF THE INSTALLATION.

57. CONCEAL ALL PIPING IN BUILDING CONSTRUCTION OR UNDERGROUND. INSTALL SUCH PIPING IN TIME SO AS NOT TO CAUSE DELAY TO WORK OF OTHER TRADES AND TO ALLOW AMPLE TIME FOR TESTS AND APPROVAL; DO NOT COVER BEFORE APPROVAL IS OBTAINED.


58. KEEP FIXTURE BRANCHES CONCEALED TO POINTS ABOVE FLOOR CLOSE TO FIXTURES; EXPOSE ONLY AS MUCH AS NECESSARY FOR FINAL CONNECTIONS.

59. WHERE FURRED SPACES ARE INDICATED, KEEP PIPES AS CLOSE TO STRUCTURAL MEMBERS AS POSSIBLE SO AS TO REQUIRE MINIMUM FURRINGS.

60. THE PLUMBING CONTRACTOR SHALL PROVIDE ESCUTCHEONS AT EACH POINT WHERE AN UNINSULATED PIPE, CONDUIT, OR TUBING PASSES THROUGH A FINISHED SURFACE. ESCUTCHEONS WILL NOT GENERALLY BE REQUIRED FOR INSULATED PIPE AND CONDUIT OR TUBING PASSING THROUGH EOUIPMENT ROOM WALLS UNLESS, IN THE OPINION OF THE ENGINEER, THE INSTALLATION OF SUCH PIPE, CONDUIT, OR TUBING HAS NOT BEEN INSTALLED IN A NEAT AND ACCEPTABLE. ESCUTCHEONS SHALL BE CONSTRUCTED OF CHROME -PLATED BRASS UNLESS SPECIFICALLY APPROVED OTHERWISE BY THE ARCHITECT. EACH ESCUTCHEON SHALL FIT FLUSH WITH THE WALL OR FLOOR AND



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TO THE BEST OF THE ARCHITECT'S OR ENGINEER'S KNOWLEDGE AND ABILITY, THE PLANS AND SPECIFICATIONS COMPLY WITH THE APPLICABLE
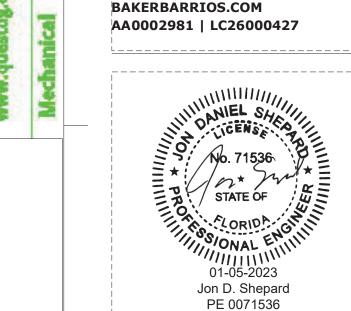
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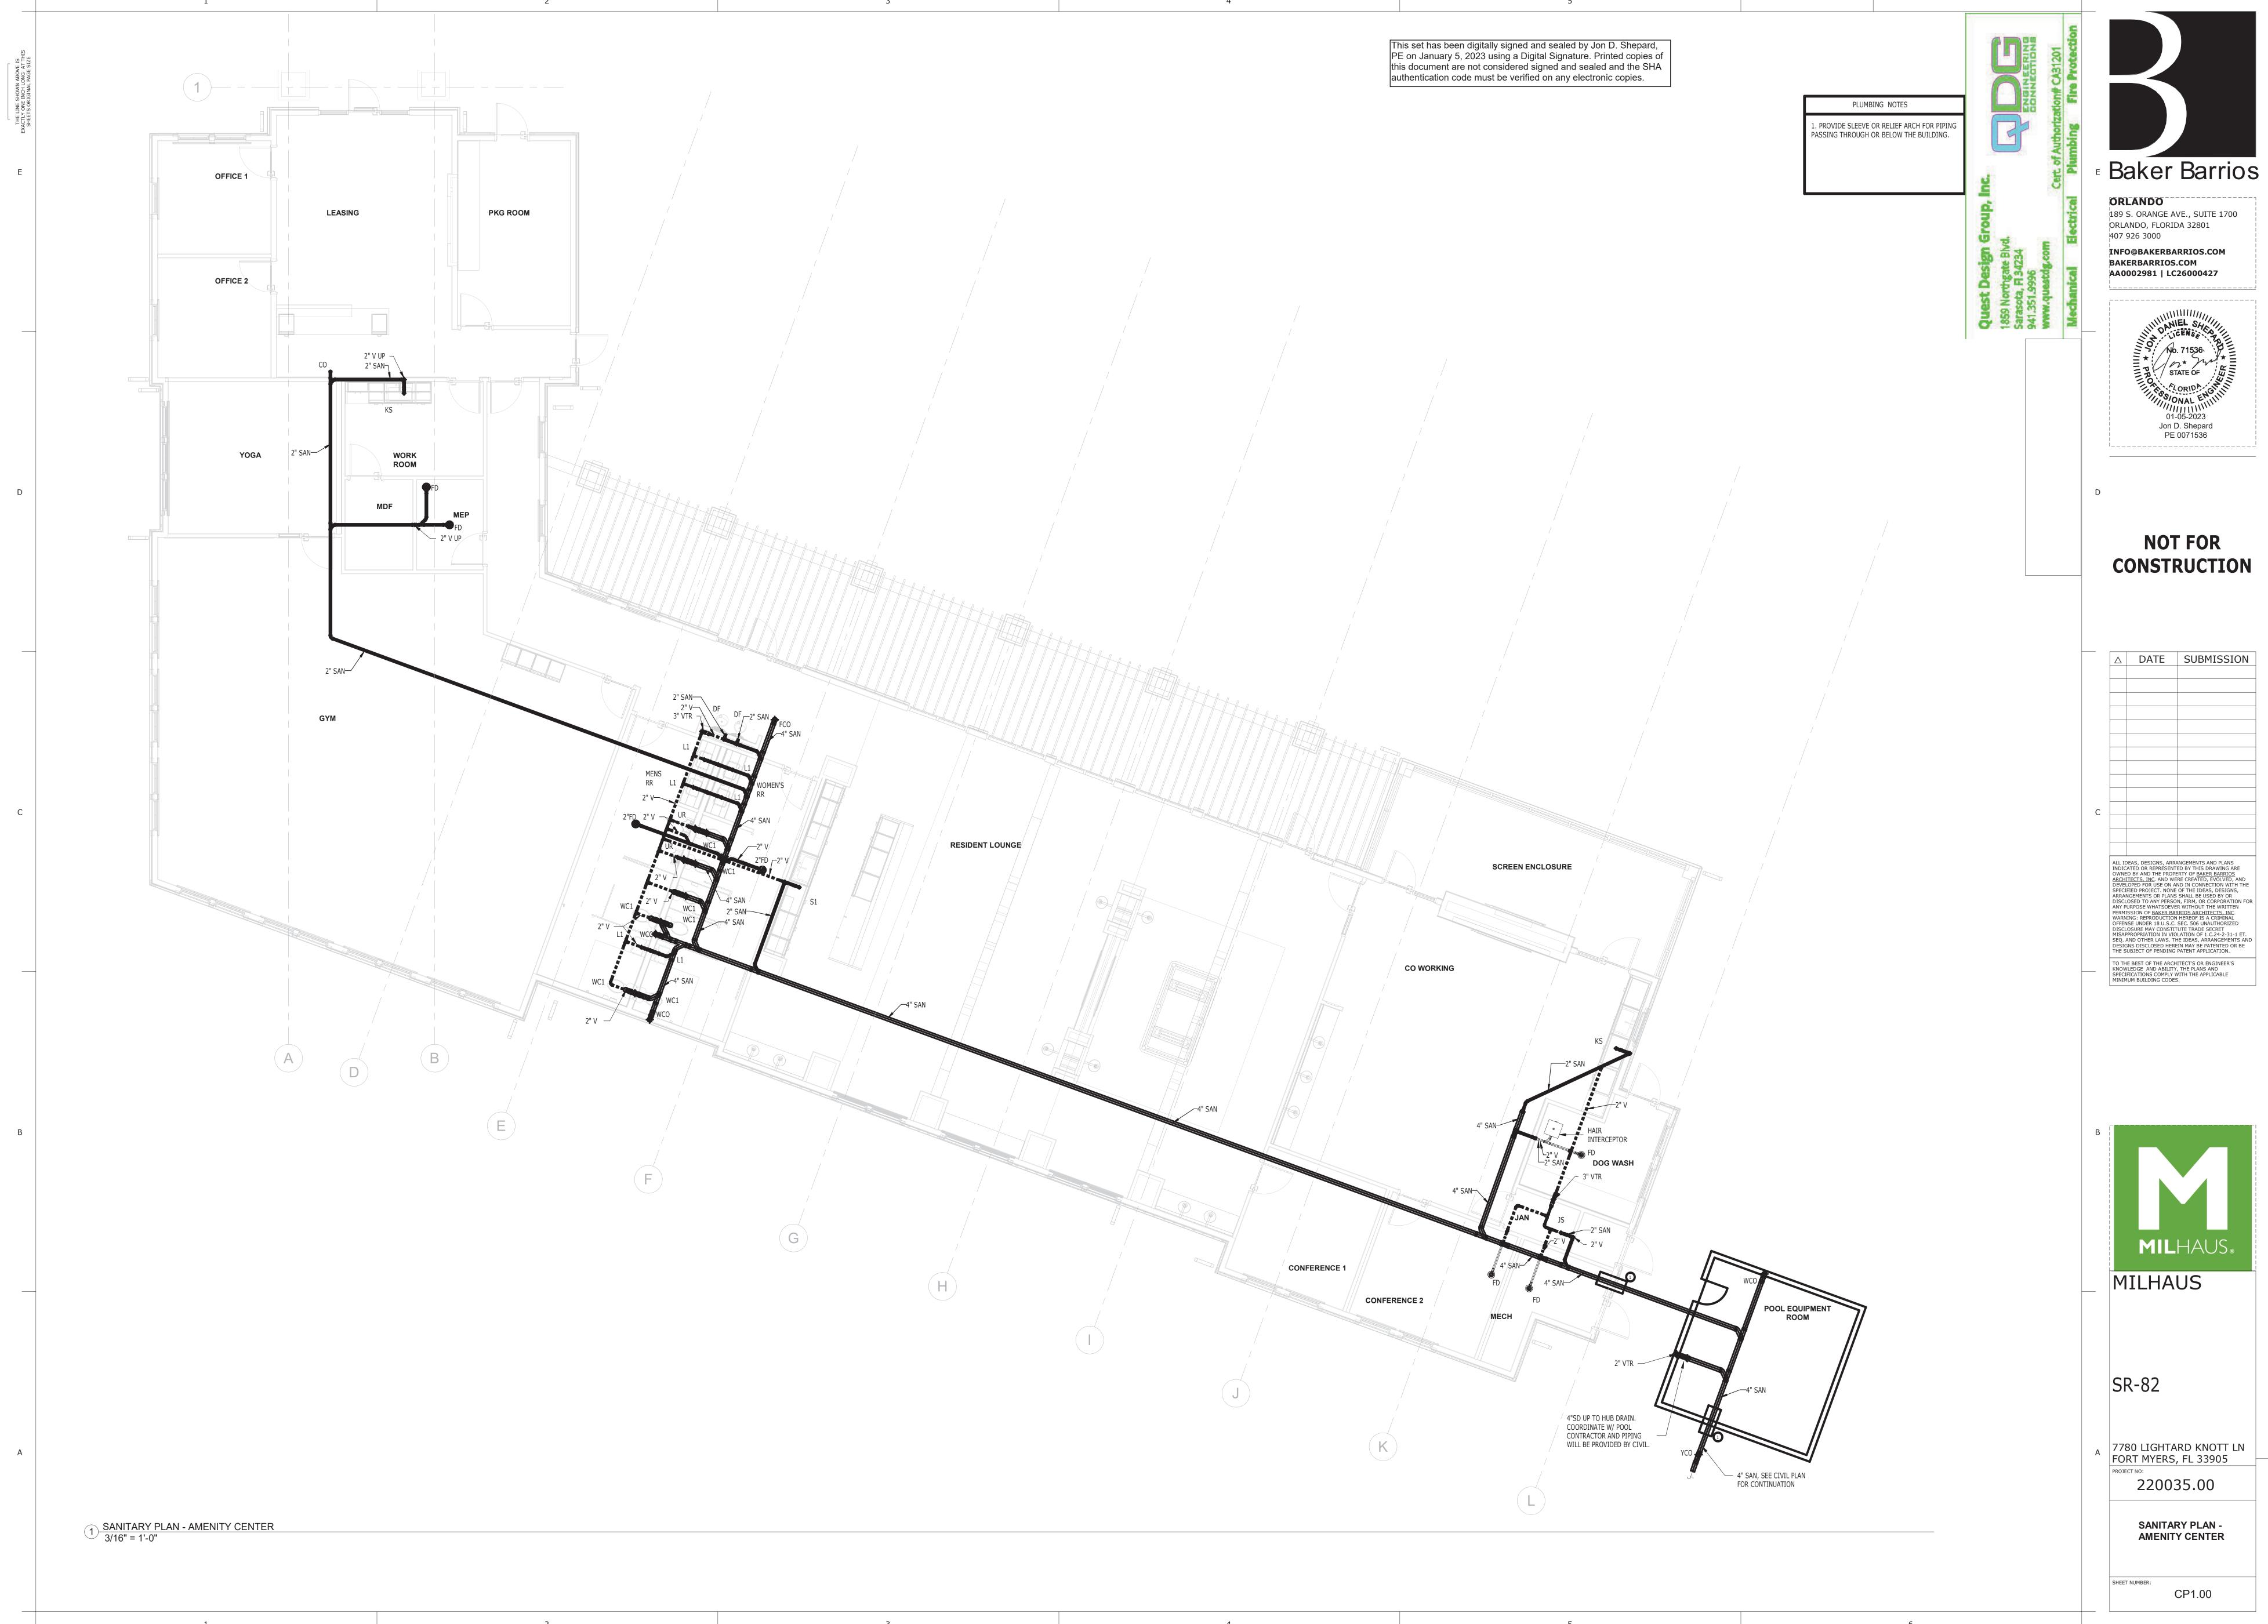
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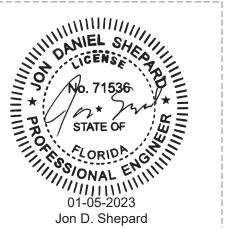
PLUMBING NOTES

SHEET NUMBER:

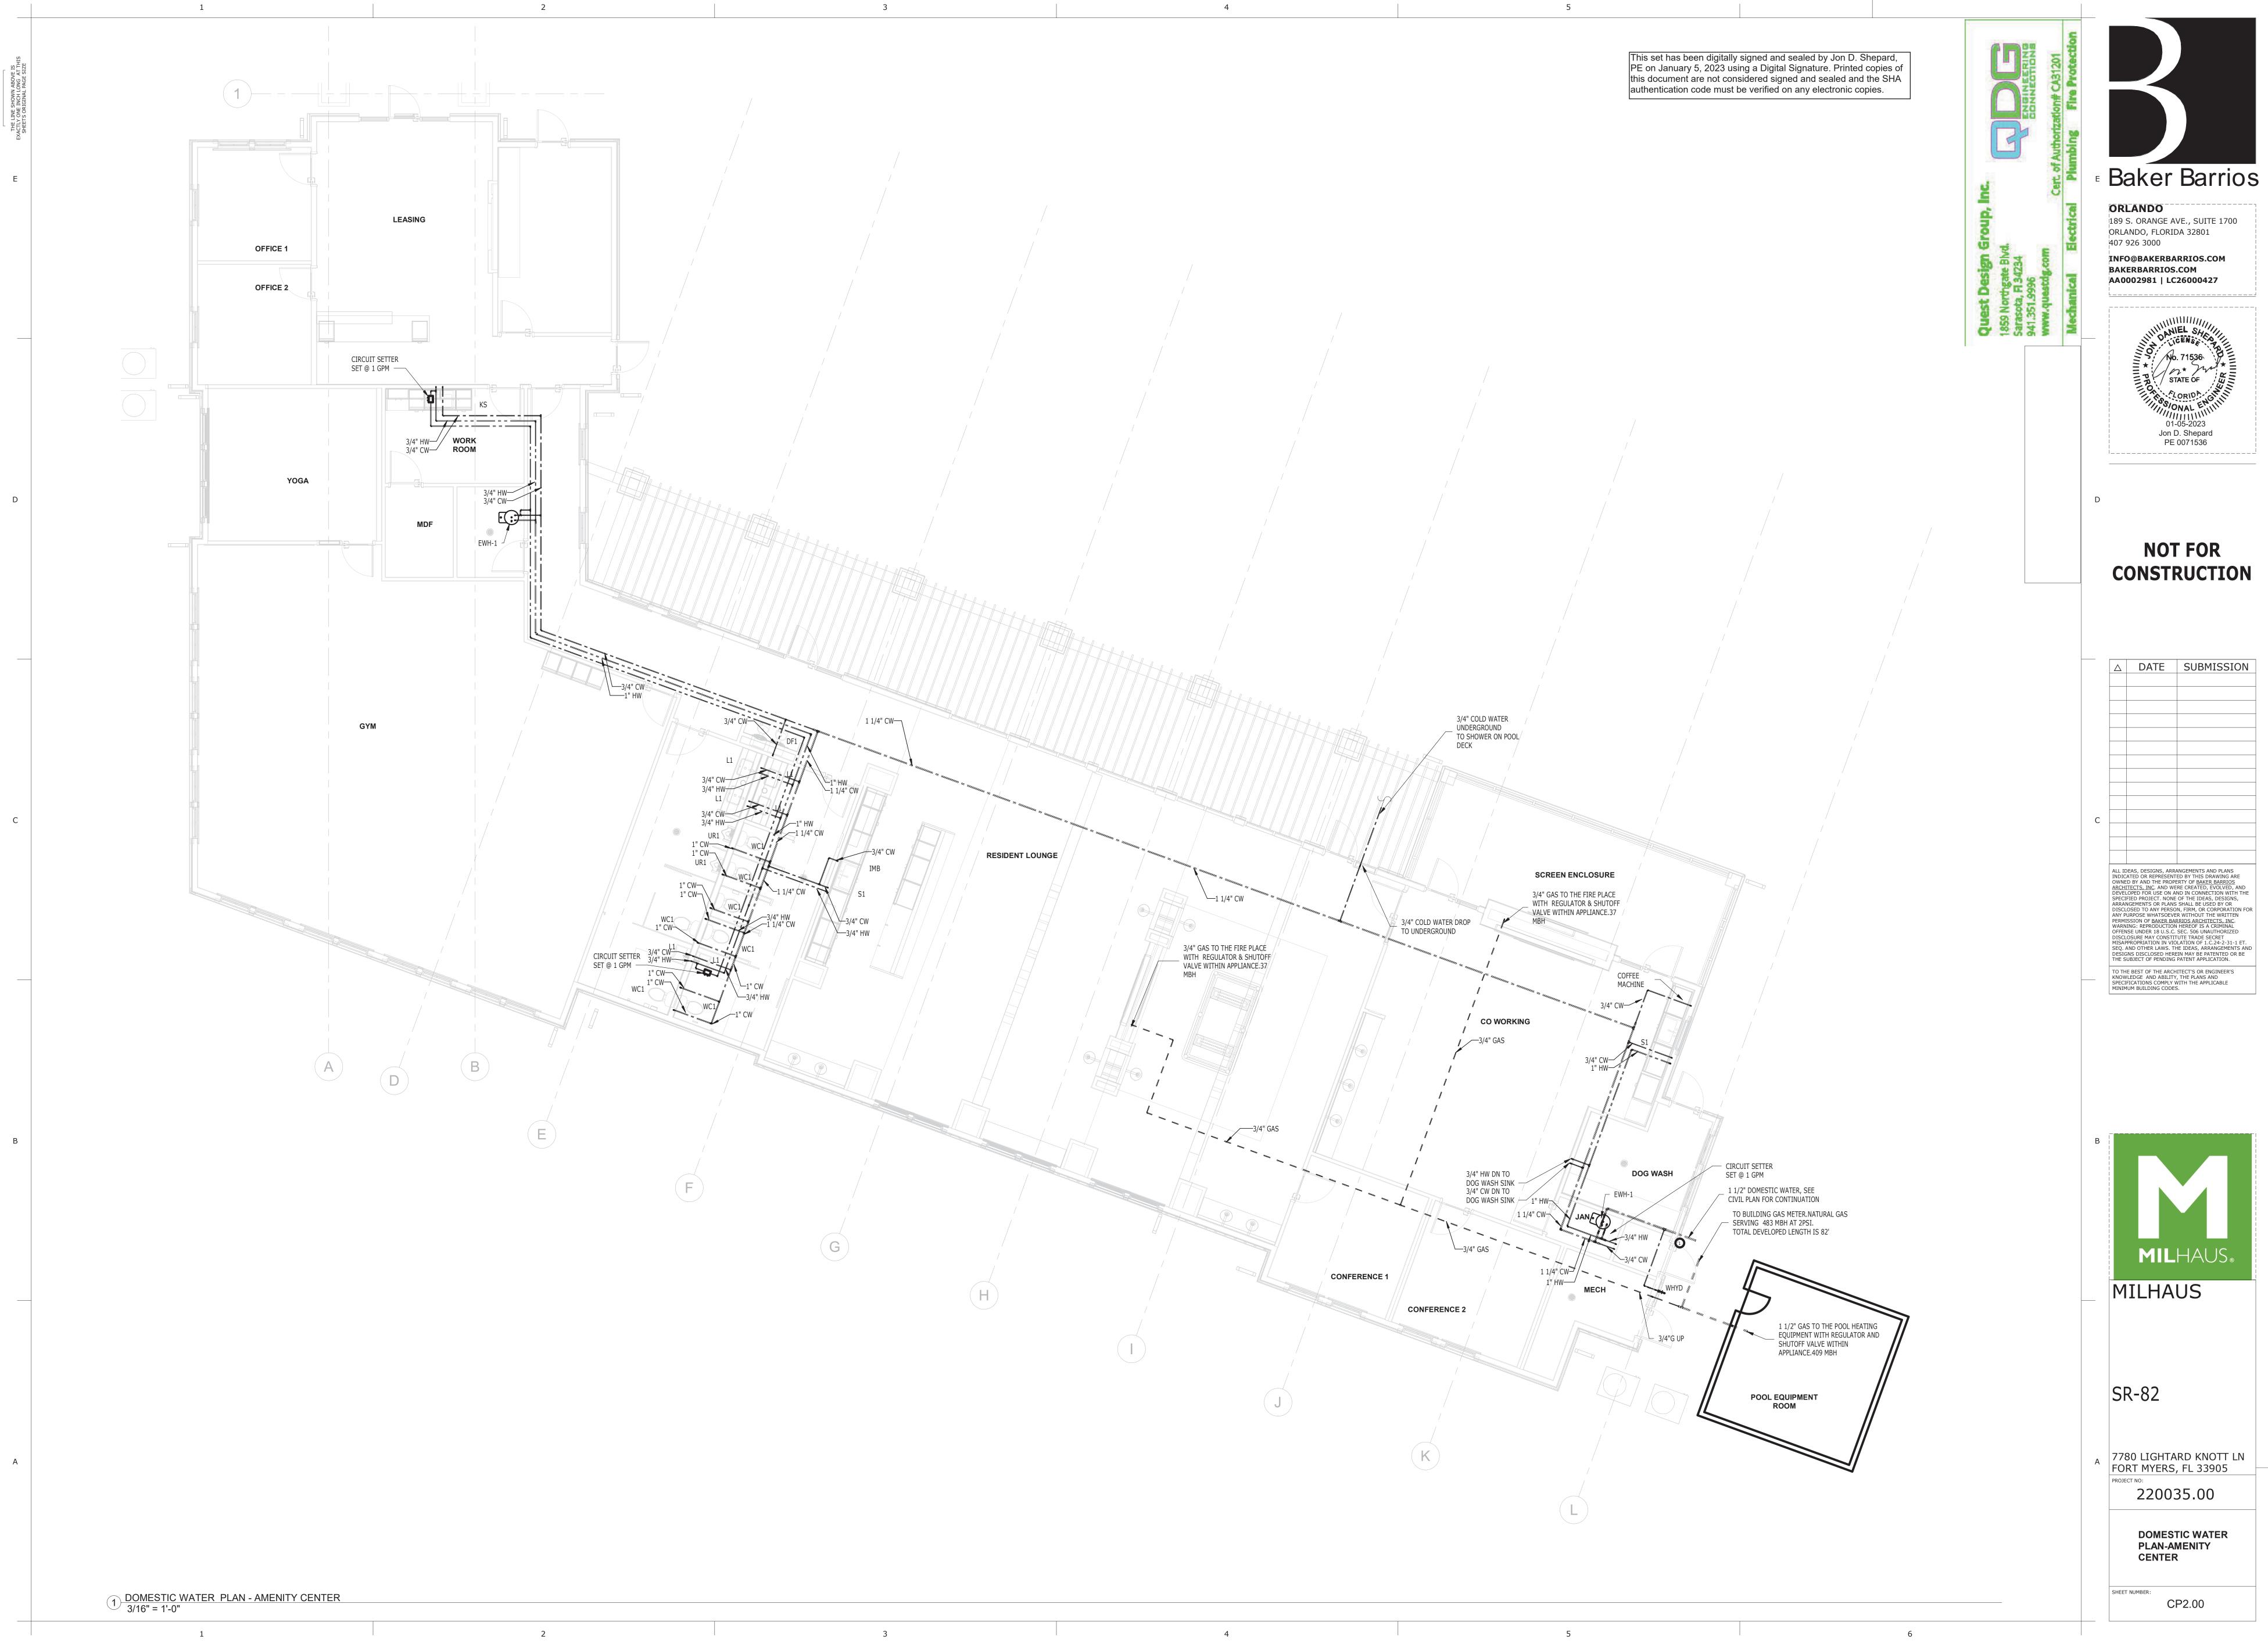
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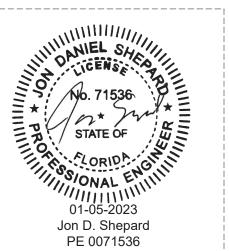








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7780 LIGHTARD KNOTT LN

220035.00

COFFEE MACHINE 15


EWH-1

3/4"CW DN TO-UNDERGROUND CIRCUIT SETTER-SET @ 1 GPM

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PLUME	BING LEGEN	IDS
FIXTURE	DFU	NOTE
WC1	4	(1)
L1	2	2
UR	2	3
S1	2	4
FD	2	(5)
JS	2	6
DF	1/2	7
HAIR INTERCEPTOR	3	8

PLI	UMBING LEGE	ENDS	
FIXTURE	CWSFU	HWSFU	NOTE
WC1	5	-	9
L1	1.5	1.5	10
UR1	3	-	1)
S1	1	1	(12)
JS	3	3	(13)
DOG WASH SINK	2	2	14
COFFEE MACHINE	1	-	(15)



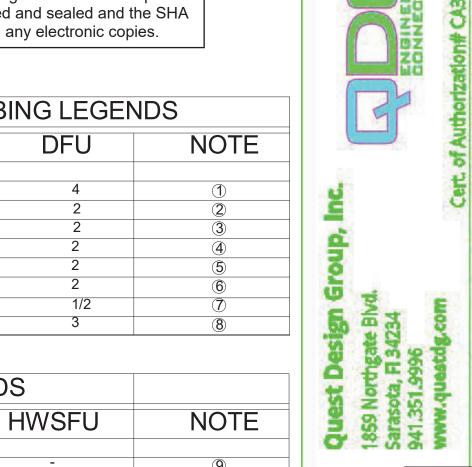

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Baker Barrios

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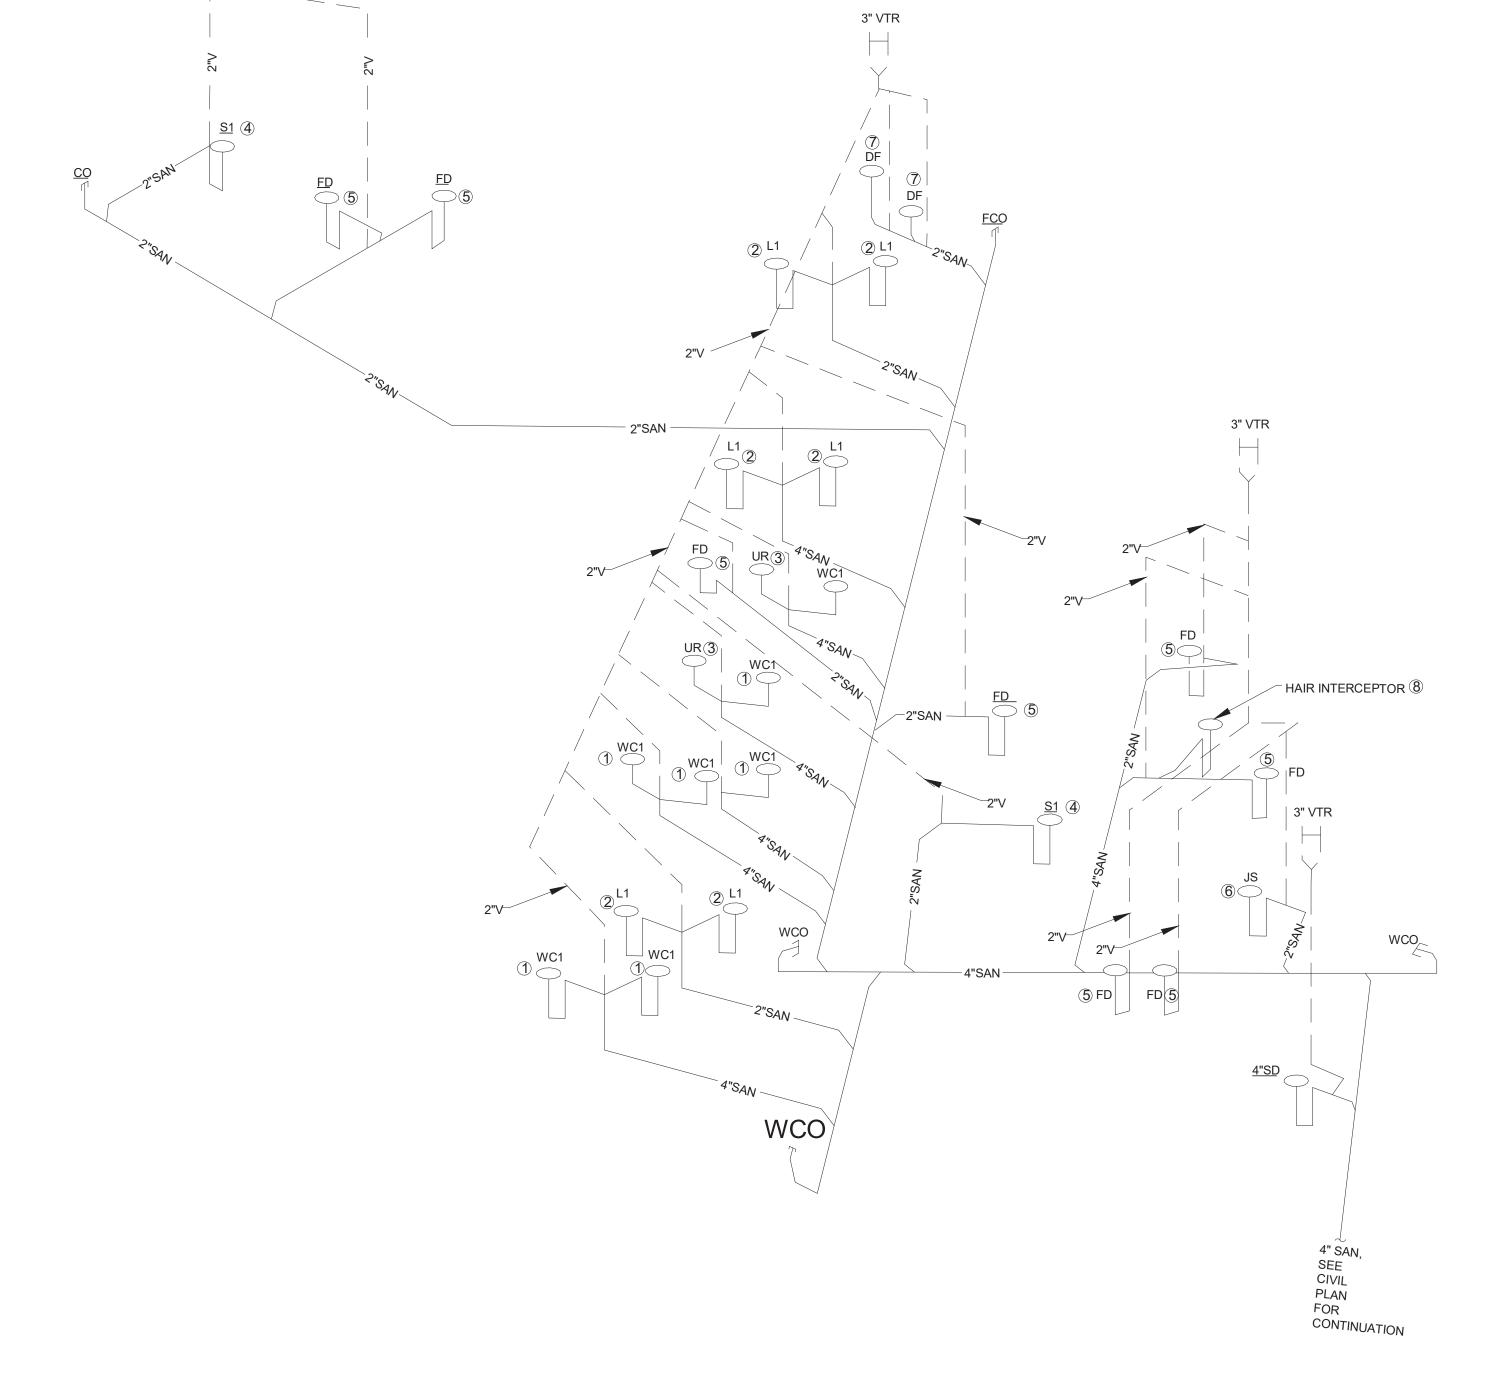


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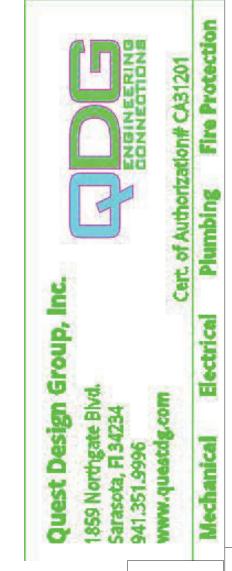
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PLUMBING RISERS

CP3.00

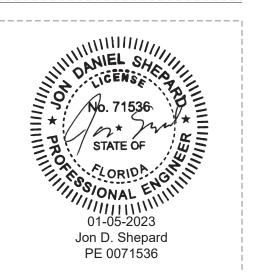








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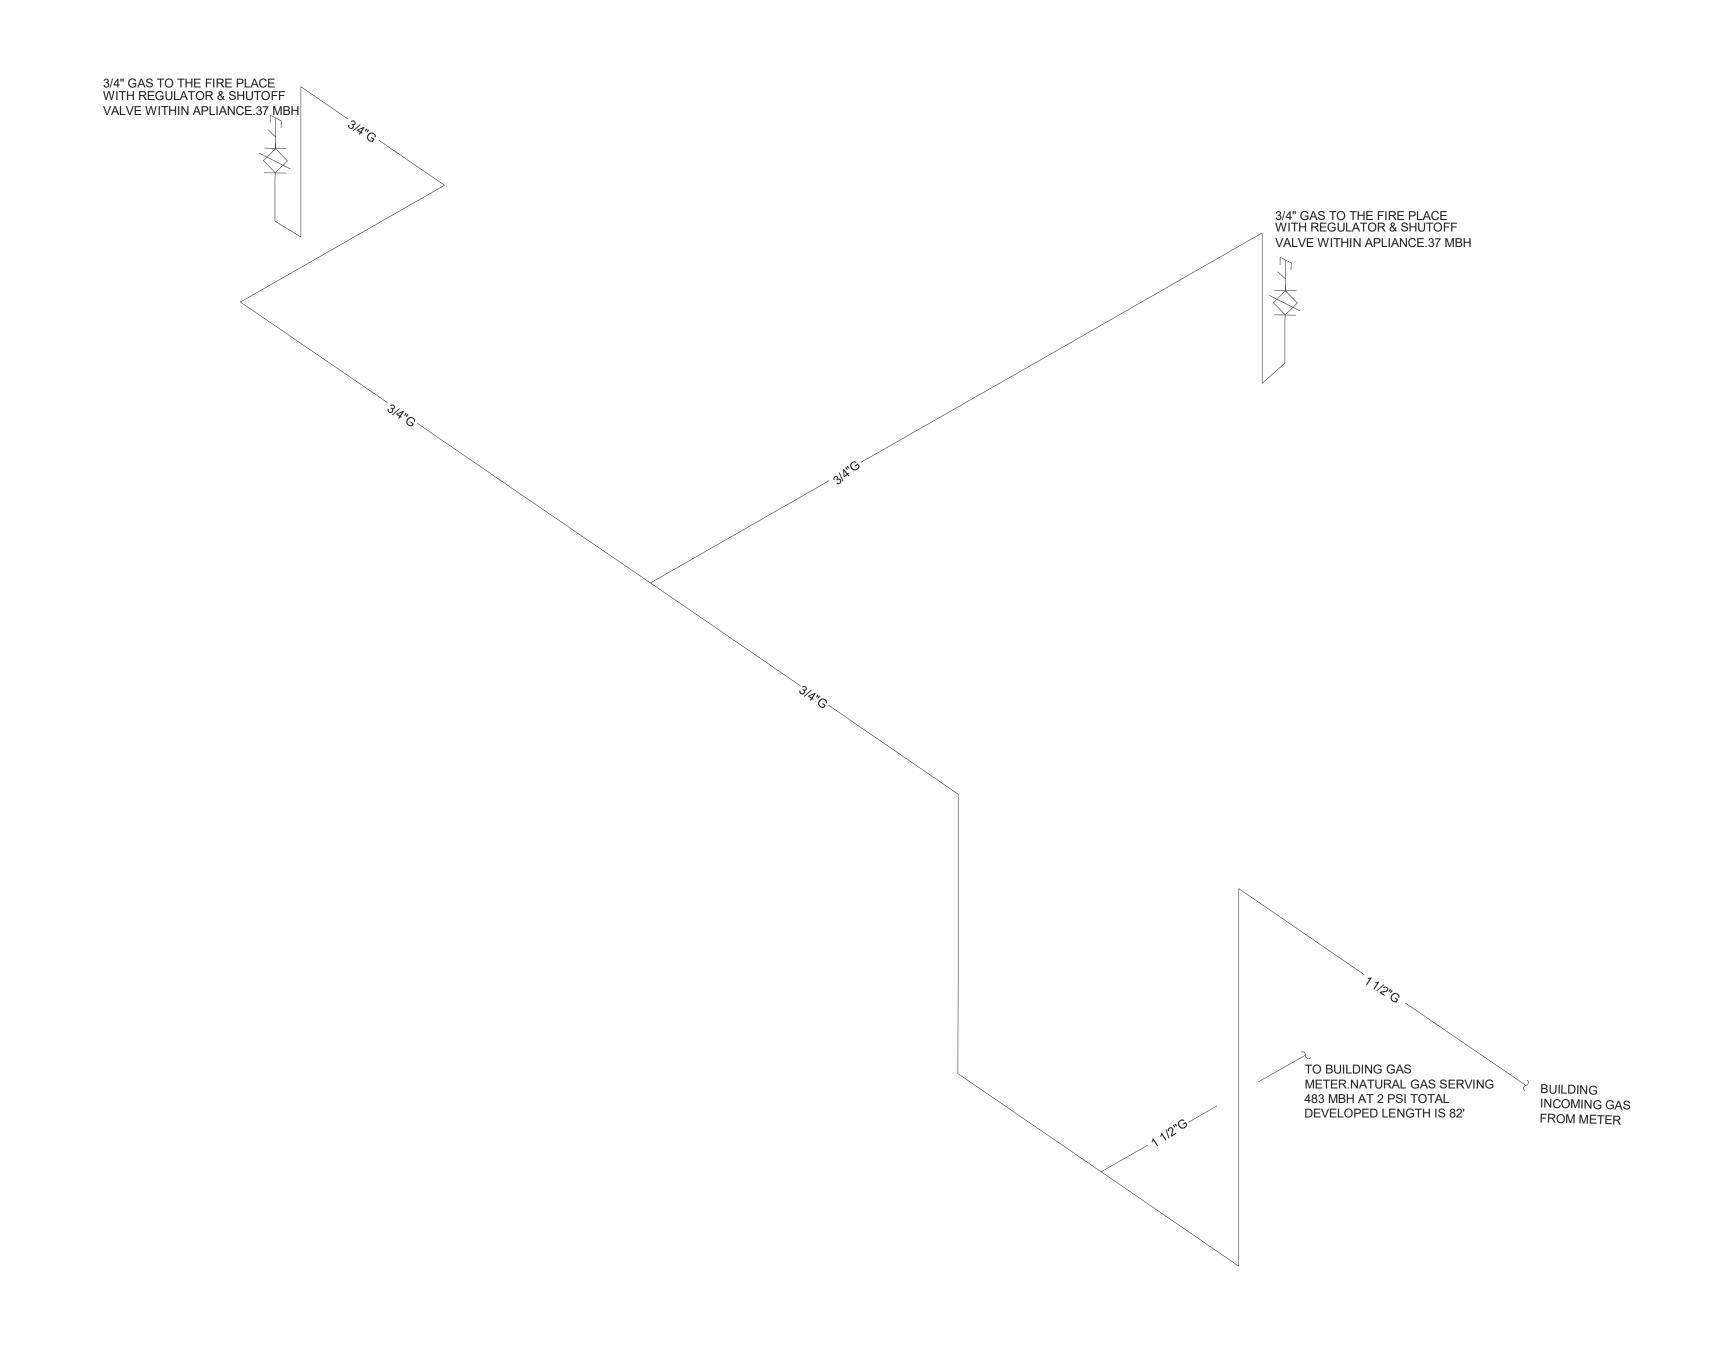
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PLUMBING GAS RISER

SHEET NUMBER:

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	FLOWIDING FIXTURE SCHEDULE AWILINITIES FIXTURE TYPE																
TAO	OHANITITY	DECODIDEION	TVDE	\/AL\/F	FALIOFT	MATERIAL			WASTE		VENT	DOMESTIC	SUPPLY	COLD	НОТ	TOTAL CURRLY	CANITADY
TAG WC1	QUANTITY 7	AMERICAN STANDARD MODEL #2467.016, "CADET" RIGHT- HEIGHT ELONGATED PRESSURE- ASSISTED	TANK, PRESSURE ASSIST	VALVE -	VITREOUS CHINA	MATERIAL VITREOUS CHINA	Fixture performance and specifications meet or exceed ASME A112.19.2-2008/CSA B45.1-08 standards, and other state and local codes.	TRAP	JIRECT 3"	INDIRECT -			HOT	WATER 5	WATER 0	TOTAL SUPPLY 35	28
<u>L1</u>	6	LAVATORY	American Standard Lucerne 0355012PL020-1/ 2" Wall Mounted Porcelain Bathroom Sink	-	Manual Sink Faucets 802-317XKAB CP	VITREOUS CHINA	UNIT TO BE PROVIDED WITH LAVATORY CARRIER ASSEMBLY, OFF-SET GRID STRAINER ASSEMBLY WITH CHROME TAILPIECE AND CHROME P-TRAP ASSEMBLY, LOOSE KEY STOPS, ESCUTHEONS, ETC. UNIT TO BE PROVIDED WITH "TRUEBRO" VINYL PIPE INSULATION KIT.		1-1/2"	-	2"	3/4"	3/4"	1.5	1.5	12	12
<u>JS1</u>	1	MOP SINK	MSB2424 - 24" X 24" Molded Stone Mop Service Basin	-	Service-Sink Faucet Model: 830-AA	STAINLESS STEEL	Tiling flanges are optional, made of stainless steel, and extend 1" above the shoulder on 1, 2, or 3 sides, as required.	3"	3"	-	2"	3/4"	3/4"	3	3	2.25	3
<u>UR</u>	2	URINAL	FLUSH VALVE	ZURN Z6203- EWS-YB	-	VITREOUS CHINA	Operates in the Range of 0.125 GPF to 1.0 GPF (gallons per flush),Meets ANSI Flush Requirements	2"	2"	-	2"	1"	-	3	-	6	4
<u>IMB</u>	1	ICE MAKER REFRIG.	WATTS #LF7RU2-2	-	-	NO-LEAD BRASS	NSF-372 compliant, IAPMO listed box and valve, ASSE 1010 arrester* Valve meets ASME A112.18.1	÷ _	-	-	-	3/4"	-	1	15	1	-
<u>DF1</u>	1	DRINKING FOUNTAIN	_	-	-	-	-	2"	2"	-	2"	3/4"	3/4"	0.25		0.25	0.5
<u>FD</u>	5	FLOOR DRAIN	Z505 HEAVY DUTY DRAIN	-	-	CAST IRON	floor drains with ASSE 1072 certified barrier-type trap seal protection devices in lieu of trap primers.	3"	3"	-	-	-	-	-	-	-	-
<u>S1</u>	3	KITCHEN SINK	ELUH2861	-	3159-DST	STAINLESS STEEL	ASME A112.19.3/CSA B45.4	1-1/2"	1-1/2"	-	1-1/2"	3/4"	3/4"	1	1	<u>4.2</u>	6
COFFEE MACHINE	2	COFFEE MACHINE	-	-	-	-	-	-	-	-	-	3/4"	-	1	-	2	-
DOG WASH	1	DOG WASH	-	-	-	STAINLESS STEEL	SL-742-L requires 17"(432) clearance above cover to remove sedimen basket	t _	-	-	-	3/4"	3/4"	2	2	4	3
RCP-1	1	RECIRCULATIO N PUMP	-	-	-	-	PUMP SHALL BE CAPABLE OF 2.5 GPM AT 9 FEET OF HEAD MINIMUM. 115 VOLTS, 60 Hz, SNGLE PHASE 0.52 AMPS, 3,250 RFM AND 1/40 HORSEPOWER. SET FLOW TO 2.5 GFM MINIMUM. PROVIDE WITH AQUASTAT AND CONNECT SYSTEM TO BUILDING TIME CLOCK, COORDINATE WITH ELECTRICAL CONTRACTOR						3/4"				

PLUMBING FIXTURE SCHEDULE AMENITIES

INSTALL BACKING AND SUPPORTS AS REQUIRED FOR ALL FIXTURES AND ACCESSORIES.

ALL FIXTURES SHALL MEET ADA AND LOCAL CODES

SUPPLY PIPING AND FITTING FOR ALL FIXTURES SHALL BE INSTALLED SO AS TO PREVENT BACKFLOW ALL FIXTURES SHALL BE PROVIDED WITH ACCESSIBLE SHUT OFF VALVES AT COLD AND HOT WATER PIPING CONNECTIONS

PROVIDE INSULATION FOR ALL PIPING IN EXTERIOR WALLS.

ALL PLUMBING FIXTURES SHALL BE COORDINATED AND APPROVED BY ARCHITECT PRIOR TO PURCHASE.

HOT WATER TO ALL LAVATORIES AND HAND SINKS SHALL NOT EXCEED 110 DEGREES.

COORDINATE ADA HEIGHT REQUIREMENTS WITH ARCHITECT DRAWINGS.

ALL HAND SINKS SHALL BE PROVIDED WITH APPROVED AUTOMATIC SAFETY WATER MIXING DEVICE AND PRESSURE BALANCE

24 SUPPLY FIXTURE UNITS FOR SPACE WHICH IS EQUAL TO 40.4 GPM AND REQUIRES NO LESS THAN A 1 1/2" PIPE.

29 DRAINAGE FIXTURE UNITS FOR THE SPACE WHICH REQUIRES NO LESS THAN 6" PIPE.


GENERAL ELECTRICAL															
QUIPMENT	LOCATION	MANUFACTURER	MODEL	LINIT TYPE	CAPACITY	WEIGHT (LBS.)	DIME		MCA	МОСР	PHASE	VOLTE	NOTES		
TAG	LOCATION	WANDFACTURER	MODEL	UNIT TYPE	(GALLONS)		DIAMETER	WIDTH	DEPTH	HEIGHT		WIOCP	PHASE	VOLIS	
EWH-1	SEE PLAN	AO SMITH	ENLB-40	TANK TYPE	38	118	23"	23"	23"	32"	4.4	15.0	1.0	240.0	2,3,4

NOTES HEATER PER APARTMENT UNIT. 2. PROVIDE ONE WATER HEATER PER APARTMENT UNIT. 3.ACCEPTABLE EQUAL MANUFACTURERS ARE A.O.SMITH, BRADFORD WHITE, LOCKINVAR, PVI, RHEEM OR STATE..

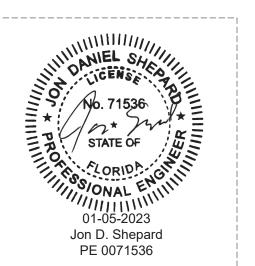4. IF WATER HEATER IS SUPPLIED WITH AN INSULATION BLANKET TO MEET THE REQUIRED ENERGY FACTOR, THE BLANKET MUST BE PLENUM RATED. NON-PLENUM RATED BLANKETS SUPPLIED BY THE MANUFACTURER MUST BE REPLACED WITH AN INSULATION BL ANKET FROM AN INSULATION MANUFACTURER THAT IS PLENUM RATED. PLENUM RATED BLANKETS ARE NOT REQUIRED IF THE WATER HEATER IS NOT IN A PLENUM OR IS NOT LOCATED IN A CLOSET SHARED WITH HVAC EQUIPMENT.



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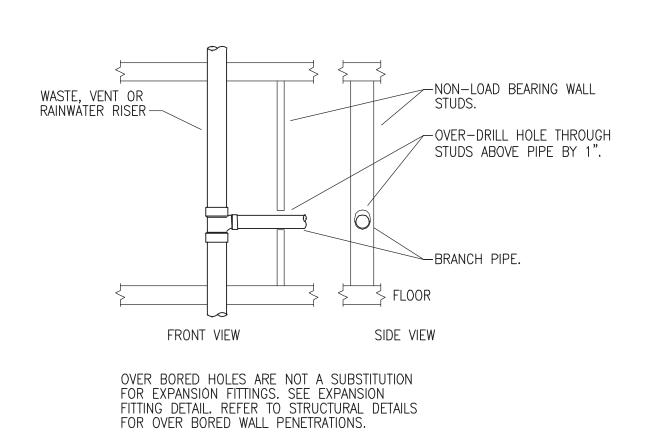
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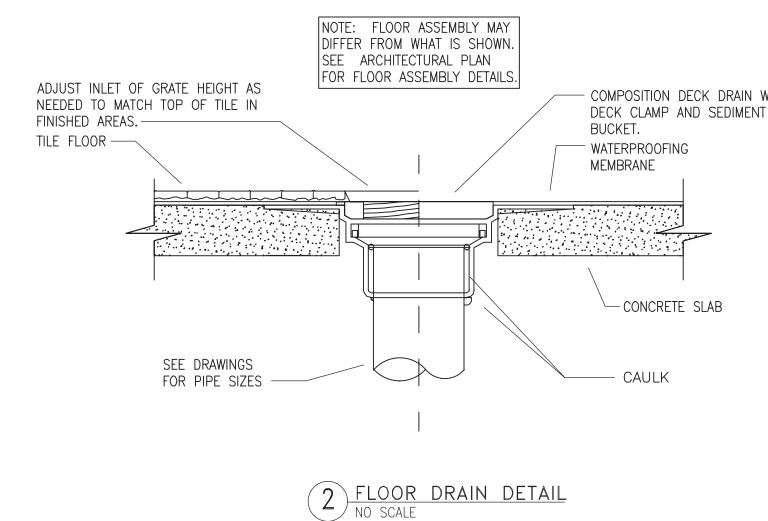
PLUMBING SCHEDULES


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CP4.00



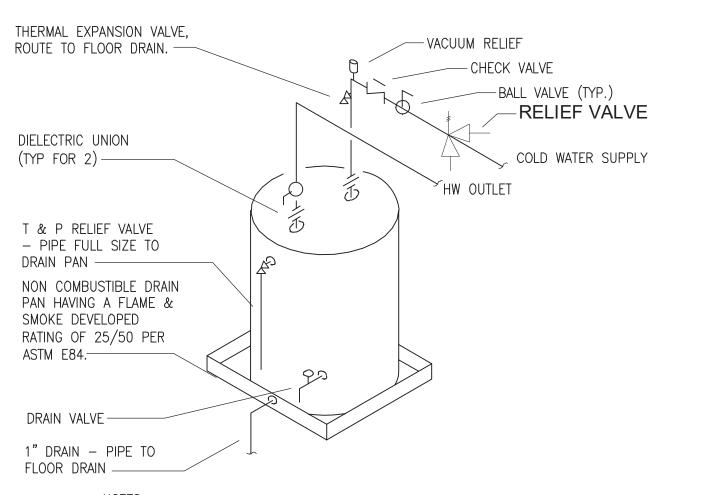1 PIPE WALL STUD PENETRATION DETAIL





1. COORDINATE PIPING WITH MECHANICAL UNIT ABOVE. PIPING AND WATER HEATER CANNOT BE GREATER THAN 42" AFF. 2. DRAIN PAN AND ALL PRODUCTS IN THE APARTMENT MECHANICAL CLOSETS SHALL BE NON-COMBUSTIBLE AND MEET THE 25/50 FLAME/SMOKE DEVELOPED RATING PER ASTM E-84. 3. PVC PIPE IS NOT ALLOWED IN THE MECHANICAL CLOSETS.

- 4. WATER HEATER SHALL BE INSTALLED TO BE EASILY ACCESSIBLE FOR MAINTENANCE AND REPLACEMENT. 5. SEE HVAC DRAWINGS FOR PLACEMENT OF WH IN RELATION TO FCU. 6. HEAT TRAPS OR HEAT TRAP NIPPLES ARE REQUIRED ON ALL WATER HEATERS. 7. THE FIRST 8 FEET OF OUTLET PIPING SHALL BE INSULATED PER ASHRAE 90.1-2010 SECTION 7.4.3.
- 5 WATER HEATER DETAIL / NO SCALE

SI-742-L

remove sediment basket.

Specification

Sediment & Hair Interceptor

hub connections. Maximum flow rate 30 GPM.

Watts SI-742-L floor mounted or recessed epoxy coated steel

large capacity sediment interceptor with gasketed epoxy coat-

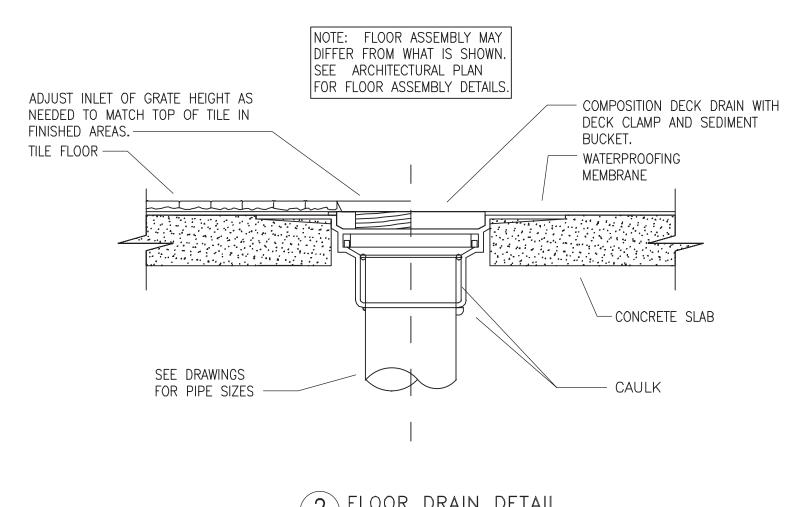
removable stainless steel dual chamber basket, and 2"(51) no

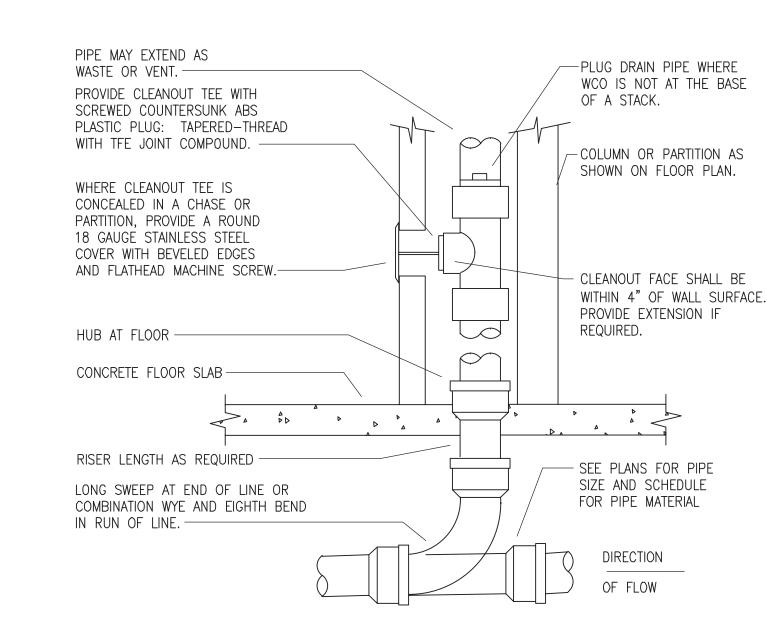
17 1/8"(435) Sq.

HAIR INTERCEPTOR DETAIL
NO SCALE

ed steel skid-proof cover secured with hex head center bolt,

Note: SI-742-L requires 17"(432) clearance above cover to






PROVIDE WCO AT BASE OF ALL WASTE STACKS AND RAIN-LEADER DOWNSPOUTS. PROVIDE WCO WHERE SHOWN ON PLAN, AND ON SANITARY WASTE BRANCHES NOT SERVED WITH A FLOOR CLEANOUT. LOCATE ABOVE FIXTURE FLOOD RIM WITHIN 4' OF FLOOR. CONSULT LOCAL CODES FOR OTHER WCO REQUIREMENTS.


6 WALL CLEANOUT DETAIL
NO SCALE

34" FLEXIBLE DRAIN SECURED TO UNDERSIDE OF COUNTER — 34" FLEXIBLE DRAIN FROM DISHWASHER WATER HAMMER 1½"W TO RISER DISPOSAL IN WALL-ARRESTOR (TYPE A) — P-TRAP-DISHWASHER STOP VALVE -%" THREE WAY ANGLE STOP VALVE FLOOR - WATT SERIES LF7 BACKFLOW PREVENTER OR EQUAL ─½" BALL VALVE

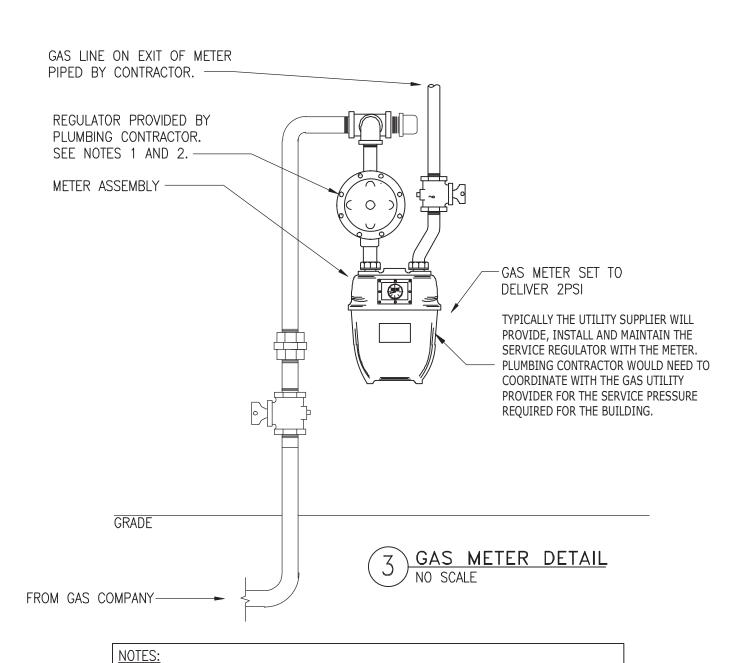
8 DISHWASHER/DISPOSAL PIPING DETAIL NO SCALE



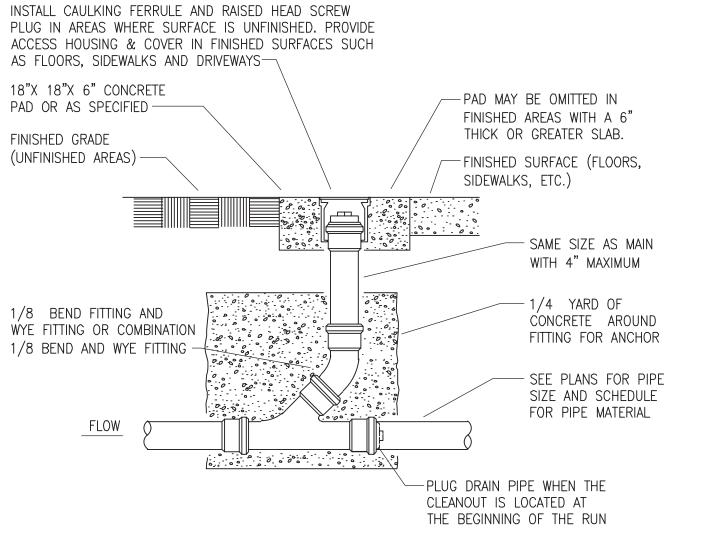REGULATOR & GAS PRESSURE SETTING SHALL BE COORDINATED WITH CONTRACTOR TO MATCH BUILDING/SUITE GAS DEMAND. REGULATOR PROVIDED BY PLUMBING CONTRACTOR SHALL BE ADJUSTABLE (10" WATER COLUMN TO 5" WATER COLUMN).




7 FLOOR/GRADE CLEANOUT DETAIL
NO SCALE

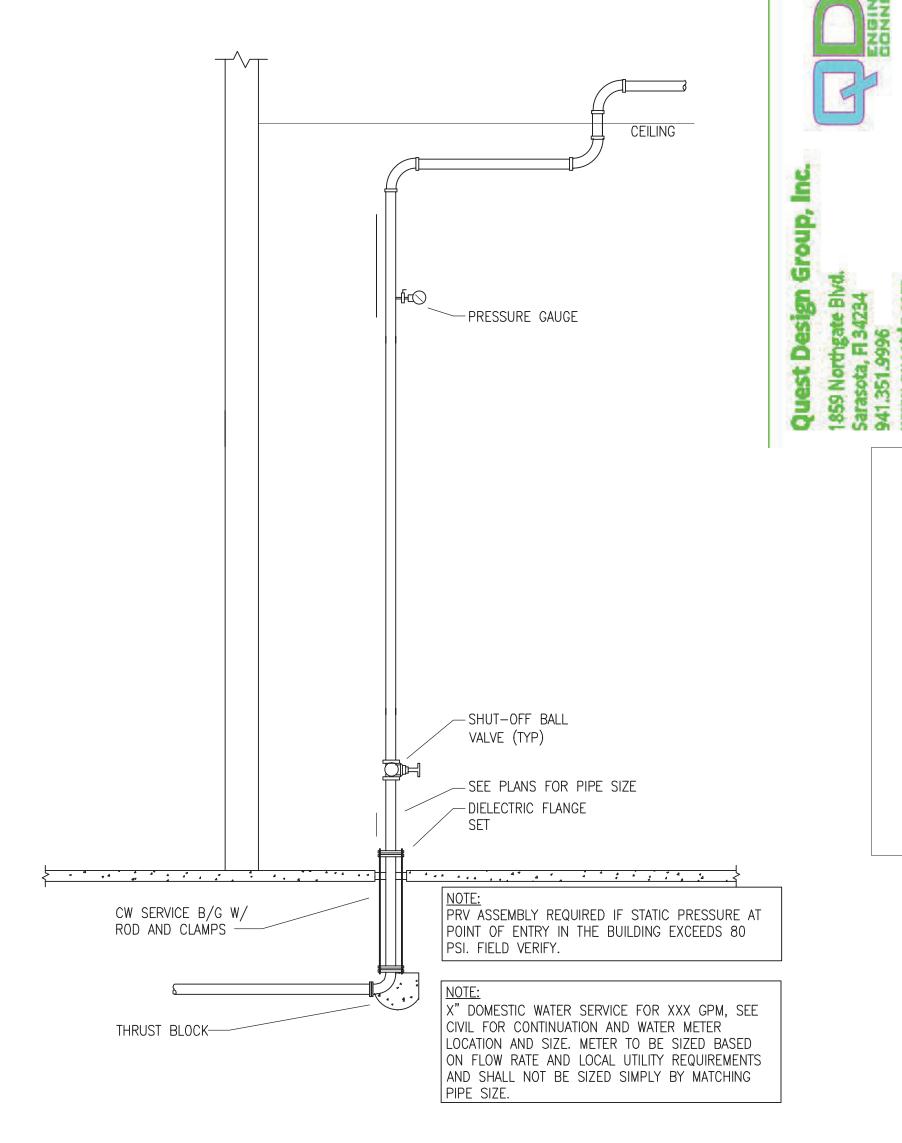

This set has been digitally signed and sealed by Jon D. Shepard, PE on January 5, 2023 using a Digital Signature. Printed copies of this document are not considered signed and sealed and the SHA authentication code must be verified on any electronic copies.

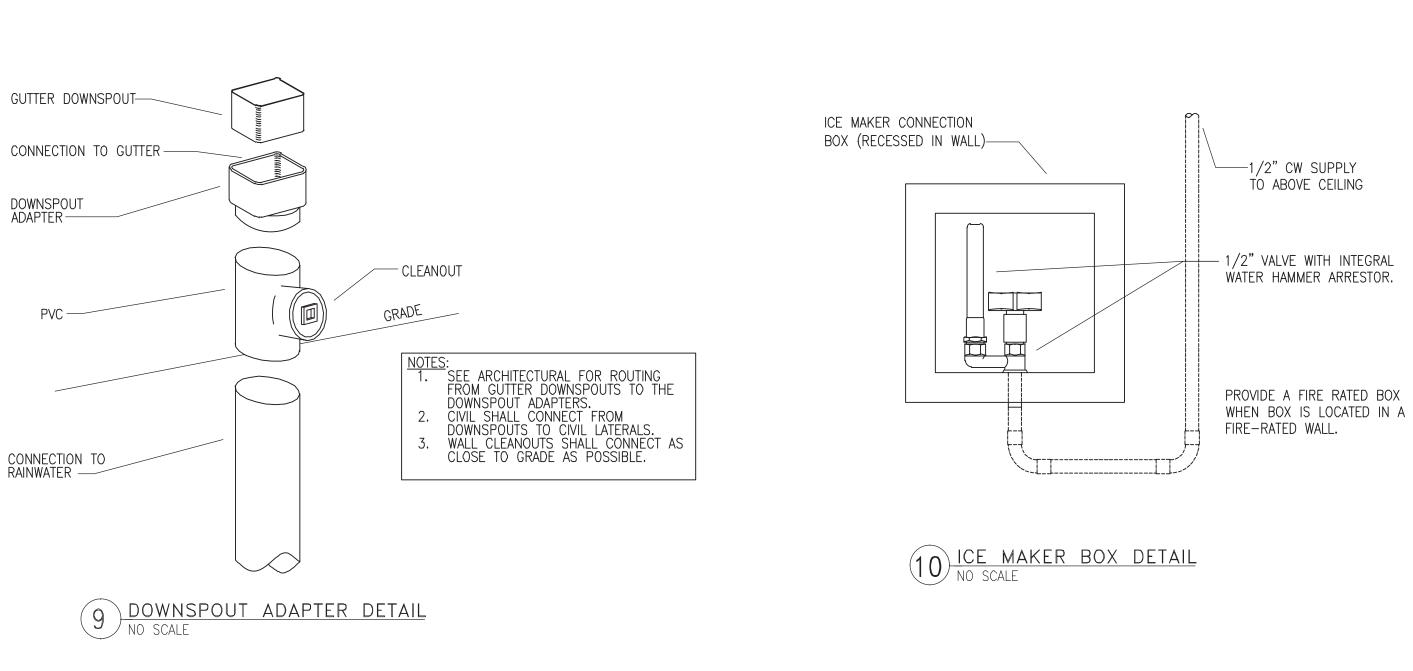
4 DOMESTIC WATER SERVICE ENTRY
NO SCALE



Baker Barrios ORLANDO

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TO THE BEST OF THE ARCHITECT'S OR ENGINEER'S KNOWLEDGE AND ABILITY, THE PLANS AND SPECIFICATIONS COMPLY WITH THE APPLICABLE MINIMUM BUILDING CODES.

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PLUMBING DETAILS

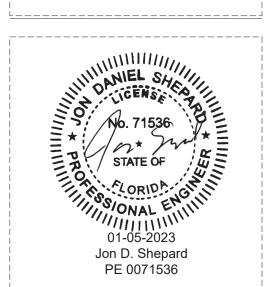CP5.00

PLUMBING GENERAL NOTES:

1. DRAWINGS ARE DIAGRAMMATIC AND INDICATE THE GENERAL ARRANGEMENT OF SYSTEMS AND WORK INCLUDED IN THE CONTRACT. DRAWINGS ARE NOT TO BE SCALED. THE ARCHITECTURAL DRAWINGS AND DETAILS SHALL BE EXAMINED FOR EXACT LOCATION OF FIXTURES AND EQUIPMENT. SYSTEMS SHALL INCLUDE ALL APPURTENANCES AS REOUIRED TO ACHIEVE THE OPERATING CONDITIONS AS SHOWN AND SPECIFIED AND SHALL RESULT IN A SUPERIOR INSTALLATION. INFORMATION CONTAINED ON THE DRAWINGS BUT NOT IN THE SPECIFICATIONS OR IN THE SPECIFICATIONS BUT NOT ON THE DRAWINGS ARE INTENDED TO BE IN BOTH, MINOR DETAILS NOT USUALLY SHOWN OR SPECIFIED BUT NECESSARY FOR PROPER OPERATION AND CONSISTENT WITH GOOD WORKMANSHIP WILL BE INCLUDED IN THE ESTIMATE, THE SAME AS IF SHOWN ON THE DRAWINGS. ANY CONFLICT SHALL BE IMMEDIATELY BROUGHT TO THE ATTENTION OF THE ARCHITECT OR ENGINEER BEFORE PROCEEDING WITH THE WORK.

2. THE PLUMBING CONTRACTOR SHALL FURNISH ALL EQUIPMENT, MATERIAL, LABOR, ETC. NECESSARY TO PROVIDE A COMPLETE, WORKABLE AND CODE APPROVED PLUMBING SYSTEM. ALL WORK SHALL BE DONE IN ACCORDANCE WITH THESE PLANS AND SPECIFICATIONS, LOCAL, STATE AND NATIONAL

3. THE PLUMBING CONTRACTOR SHALL GIVE ALL NECESSARY NOTICES, OBTAIN ALL PERMITS AND PAY ALL GOVERNMENT FEES, SALES TAXES AND OTHER COSTS IN CONNECTION WITH HIS WORK; FILE ALL NECESSARY APPROVALS OF ALL GOVERNMENTAL DEPARTMENTS HAVING JURISDICTION; OBTAIN ALL REQUIRED CERTIFICATES OF INSPECTION FOR HIS WORK; AND DELIVER TO THE ARCHITECT THE SAME CERTIFICATES BEFORE REQUEST FOR ACCEPTANCE AND FINAL PAYMENT FOR THE WORK.

4. ALL WORK SHALL BE GUARANTEED, BOTH MATERIAL AND INSTALLATION, FOR A PERIOD OF ONE YEAR FROM ACCEPTANCE BY OWNER.

5. FURNISH SIX (6) COPIES OF SHOP DRAWINGS OF EQUIPMENT OR FIXTURES FOR APPROVAL PRIOR TO PURCHASING.

6. CONTRACTOR SHALL KEEP A RECORD OF THE LOCATIONS OF ALL CONCEALED WORK AND UPON COMPLETION OF THE JOB, SHALL SUPPLY ACAD QUALITY AS-BUILT DRAWINGS SHOWING ANY DEVIATION FROM THE ORIGINAL DRAWINGS. THESE DRAWINGS SHALL INDICATE DIMENSIONS OF BURIED UTILITY LINES FROM BUILDING WALLS.

7. THE PLUMBING CONTRACTOR SHALL COORDINATE WITH ALL TRADES FOR PIPE ROUTING AND INSTALLATION OF EQUIPMENT AND SYSTEMS TO PROVIDE FOR REQUIRED CLEARANCES.

8. ALL OPENINGS THROUGH FIRE RATED WALLS OR FLOORS SHALL BE SEALED WITH A U.L. LISTED PENETRATION AND SHALL MAINTAIN THE FIRE RATED INTEGRITY OF THE WALL OR FLOOR. THE CONTRACTOR SHALL VERIFY FIRE RATINGS WITH ARCHITECTURAL DRAWINGS PRIOR TO INSTALLATION.

9. PIPE PASSING THROUGH PIT WALLS, BUILDING WALLS, AND BUILDING FLOORS BELOW GRADE SHALL BE PROVIDED WITH SLEEVES OF STANDARD WEIGHT GALVANIZED STEEL PIPE. THE ANNULAR SPACES BETWEEN PIPE AND SLEEVES SHALL BE SEALED WITH LINK SEAL HYDROSTATIC PIPE WALL SEAL. SLEEVES SHALL BE SIZED AS FOLLOWS:

3" PIPE - 6" ID SLEEVE 4" PIPE - 8" ID SLEEVE 6" PIPE - 10" ID SLEEVE 8" PIPE - 12" ID SLEEVE 10" PIPE - 12" ID SLEEVE

10. BREAKAGE AND CORROSION: PIPES PASSING UNDER OR THROUGH WALLS SHALL BE PROTECTED FROM BREAKAGE. PIPES PASSING THROUGH CONCRETE OR CINDER WALLS AND FLOORS OR OTHER CORROSIVE MATERIAL SHALL BE PROTECTED AGAINST EXTERNAL CORROSION BY A PROTECTIVE SHEATHING OR WRAPPING OR OTHER MEANS THAT WILL WITHSTAND ANY REACTION FROM LIME AND ACID OF CONCRETE, CINDER OR OTHER CORROSIVE MATERIAL. SHEATHING OR WRAPPING SHALL ALLOW FOR EXPANSION AND CONTRACTION OF PIPING TO PREVENT ANY RUBBING ACTION. MINIMUM WALL THICKNESS OF MATERIAL IS TO BE 0.025 INCH.

11. PROVIDE WALL CARRIERS FOR ALL WALL HUNG PLUMBING FIXTURES. ALL WALL HUNG PLUMBING FIXTURES SHALL BE CAPABLE OF SUPPORTING A 250 POUND VERTICAL LOAD.

12. THE PLUMBING CONTRACTOR SHALL VERIFY SIZE AND LOCATION OF ALL EXISTING SERVICES PRIOR TO COMMENCING WITH THE WORK.

LINES TO EXISTING SERVICE LINES AT LOCATION ON SITE OR IN BUILDING AS REQUIRED. VERIFY EXACT LOCATION AND INVERT ELEVATION OF SERVICE CONNECTIONS PRIOR TO CONSTRUCTION. CONTRACTOR SHALL NOTIFY ENGINEER IMMEDIATELY IF THE DISTANCE TO SITE SERVICES EXCEED TEN (10) LINEAR FEET FROM THE BUILDING.

14. OFFER REMOVED MATERIAL TO THE OWNER. REMOVE ALL MATERIAL REJECTED BY THE OWNER FROM THE WORK SITE AND DISPOSE OF IN ACCORDANCE WITH APPLICABLE LOCAL, STATE AND NATIONAL CODES. CONTRACTOR MUST CERTIFY TO OWNER THAT THE MATERIAL HAS BEEN LEGALLY DISPOSED OF.

POTABLE WATER PIPING:

15. BELOW GROUND WATER PIPING SHALL BE TYPE "K" COPPER WITH VINYL SLEEVE FOR CORROSION PROTECTION WITH WROUGHT COPPER FITTINGS AND 95-5 SOLDERED JOINTS.

16. ABOVE GROUND WATER PIPING SHALL BE TYPE "L" COPPER WITH WROUGHT COPPER FITTINGS AND 95-5 SOLDERED JOINTS.

17. INTERIOR ABOVE AND BELOW GROUND WATER PIPING SHALL BE (CPVC) CHLORINATE POLYVINYL CHLORIDE PLASTIC PIPE AND TUBING (ASTM D-2846) FLOWGUARD OR EQUIVALENT WITH APPROVED CPVC SOLVENT WELDED FITTINGS. CPVC WATER PIPING SHALL NOT BE RUN IN RETURN AIR PLENUM OR

FIRE RATED ASSEMBLIES UNLESS ALLOWED BY LOCAL JURISDICTION.

17a. INTERIOR ABOVE AND BELOW GROUND WATER PIPING SHALL BE CROSSLINKED POLYETHYLENE (PEX-a) STRAIGHT, COILED AND EXPANSION LOOPED PIPE AND TUBING (ASTM F876 AND F877) UPONOR AQUAPEX WHITE OR EQUIVALENT WITH COLD-EXPANSION FITTINGS (ASTM F877 AND F1960) LEAD FREE DEZINCIFICATION RESISTAND BRASS COUPLINGS, FITTINGS AND VALVES (ASTM F877 AND F1960) FOR ABOVE AND UNDERGROUND INSTALLATIONS AND/OR ENGINEERED POLYMER (ASTM F877 AND F1960) FOR ABOVE GROUND INSTALLATIONS. PEX-a WATER PIPING SHALL NOT BE RUN IN RETURN AIR PLENUM UNLESS INSTALLED PER MANUFACTURER'S WRITTEN INSTRUCTIONS FOR RETURN AIR PLENUM INSTALLATION AND APPROVED BY LOCAL JURISDICTION. PEX MANUFACTURE SHALL PROVIDE SHOP DRAWINGS INDICATING THE SYSTEM(S) HAVE BEEN ANALYZED FOR USE OF PEX PIPING FOR

18. EXTERIOR BUILDING SERVICE SHALL BE SCHEDULE 40 PVC (ASTM D-1785) WITH APPROVED PVC SOLVENT WELDED FITTINGS.

19. INTERIOR ABOVE AND BELOW GRADE HIGH TEMPERATURE HOT WATER (140°F OR GREATER) PIPING SHALL BE TYPE "L" HARD DRAWN COPPER TUBE WITH COPPER FITTINGS AND 95-5 SOLDERED JOINTS.

20. THE SITE SUBCONTRACTOR SHALL PROVIDE THE BACKFLOW PREVENTOR AND THE WATER METER. 21. A SERVICE VALVE SHALL BE PROVIDED ON THE DOMESTIC WATER RISER AT 5'-0" ABOVE FINISHED FLOOR, WHERE WATER ENTERS THE BUILDING.

22. PROVIDE WATER HAMMER ARRESTORS ON HOT AND COLD WATER LINES ON ALL QUICK CLOSING DEVICES PER CHAPTER 6 OF FLORIDA BUILDING CODE PLUMBING.

23. PROVIDE VACUUM BREAKERS AS REQUIRED BY CODE.

24. TEST ALL WATER PIPING AT 100 PSIG FOR TWENTY-FOUR (24) HOURS OR AS REQUIRED BY CODE. 25. STERILIZE ALL WATER PIPING IN ACCORDANCE WITH HEALTH DEPARTMENT REGULATIONS AND AMERICAN WATER WORKS SPECIFICATIONS.

26. SUPPORT ALL WATER PIPING WITH PIPE HANGERS BY GRINNELL OR EQUAL.

27. PROVIDE RISER CLAMPS AT EACH FLOOR FOR ALL VERTICAL PIPING INCLUDING SANITARY DRAINS, VENTS, AND WATER LINES. INSTALL RISERS SO AS TO ALLOW VERTICAL MOVEMENT OF PIPING, ANCHORING PIPES AT THE BASE OF ALL RISERS.

28. PROVIDE ACCESS DOORS WHERE NECESSARY TO SERVICE SEALS, VALVES, TRAPS, CLEAN-OUTS, AIR CHAMBERS/WATER HAMMER ARRESTORS, ETC. ALL ACCESS DOORS IN TOILET ROOMS SHALL BE STAINLESS STEEL.

29. PROVIDE DIELECTRIC UNIONS OR FITTINGS WHENEVER FERROUS AND NON-FERROUS PIPES ARE

30. INSULATE HOT WATER PIPING WITH 1 INCH ARMSTRONG AP ARMAFLEX UP TO AND INCLUDING 1 1/4-INCH DIAMETER. SECURE WITH ADHESIVE.

31. INSULATE HOT WATER PIPING OVER 1 1/4-INCH WITH 1 INCH THICK FIBERGLASS PIPE COVERING FINISHED WITH WHITE MASTIC. FITTINGS SHALL BE INSULATED WITH MITERED PIPE COVERING FINISHED WITH WHITE MASTIC OR PVC FITTING COVERS.

32. HANDICAPPED LAVATORIES: INSULATE WATER SUPPLIES AND WASTE PIPING REQUIRING ADA CONFORMANCE, WITH LAV-GUARD KITS, BY TRUEBRO OR EQUAL.

33. THIS SYSTEM WAS DESIGNED TO 50 PSI STATIC PRESSURE WITH RESIDUAL PRESSURE OF 20 PSI AT 1000 GPM FROM THE NEAREST FIRE HYDRANT. THESE CONDITIONS SHALL BE VERIFIED BY THE PLUMBING CONTRACTOR PRIOR TO PROCEEDING WITH THE INSTALLATION. NOTIFY THE ENGINEER IMMEDIATELY IF FLOW AND PRESSURES OBTAINED ARE BELOW THOSE CONTAINED IN THIS

34. WATER HEATERS: WATER HEATERS MUST BEAR ASHRAE LABEL INDICATING COMPLIANCE WITH ASHRAE STANDARD 90 OR COMPLY WITH EFFICIENCY AND STANDBY LOSS REQUIREMENTS. SWITCH OR CLEARLY MARKED CIRCUIT BREAKER (ELECTRIC) OR CUT-OFF (GAS) MUST BE PROVIDED. HEAT TRAPS REQUIRED. MUST MEET MINIMUM WATER HEATING EQUIPMENT EFFICIENCIES AS ESTABLISHED BY THE FLORIDA MODEL ENERGY CODE.

SANITARY WASTE, VENT AND STORM PIPING

FRESH AIR INTAKES.

35, SANITARY WASTE AND VENT PIPING SHALL BE SCHEDULE 40 PVC (ASTM D-2665) WITH APPROVED PVC SOLVENT WELDED FITTINGS. COMPLY WITH 2020 FLORIDA BUILDING CODE. PVC PIPING SHALL NOT BE RUN IN RETURN AIR PLENUM OR FIRE RATED ASSEMBLIES.

36. SANITARY WASTE AND VENT PIPING SHALL BE SERVICE WEIGHT CAST IRON, NO-HUB WITH

STAINLESS STEEL CLAMPS AND SHIELDS WITH NEOPRENE SEALING SLEEVES. 37. ALL SOIL AND WASTE PIPING, 2-1/2" AND SMALLER, SHALL BE SLOPED AT 1/4" PER FOOT. LARGER

WASTE PIPING SHALL BE SLOPED AT 1/8" PER FOOT. 38. TEST SANITARY WASTE AND VENT PIPING BY A 10' WATER COLUMN FOR TWENTY-FOUR (24) HOURS

OR AS REQUIRED BY THE BUILDING DEPARTMENT. 39. ALL VENTS THROUGH ROOF SHALL BE A MINIMUM OF 10'-0" OR AS REQUIRED BY CODE AWAY FROM

40. ALL VENTS THROUGH ROOF SHALL BE PROVIDED WITH FOUR (4) POUND SHEET LEAD FLASHING EXTENDING UPWARD AROUND THE PIPE AND TURNED DOWN INSIDE THE PIPE.

41. FLOOR DRAINS TO HAVE 4-INCH DEEP SEAL TRAPS. EXACT DRAIN LOCATION SHALL BE COORDINATED WITH ARCHITECT PRIOR TO ROUGH IN.

42. FLOOR SINKS TO HAVE 4-INCH DEEP SEAL TRAPS. EXACT DRAIN LOCATION SHALL BE COORDINATED WITH ARCHITECT PRIOR TO ROUGH IN.

43. PROVIDE ASSE 1072 CERTIFIED TRAP SEAL BARRIERS FOR ALL FLOOR DRAINS AND HUB DRAINS

THAT ARE NOT CONTINUOUSLY WASHED BY AN APPLIANCE OR FIXTURE. 44. SANITARY WASTE, VENT AND STORM PIPING SHALL BE SCHEDULE 40 PVC (ASTM D-2665) WITH

APPROVED PVC SOLVENT WELDED FITTINGS. COMPLY WITH 2020, 7th EDITION FLORIDA BUILDING

CODE. PVC PIPING SHALL NOT BE RUN IN RETURN AIR PLENUM OR FIRE RATED ASSEMBLIES. 45. SANITARY WASTE, VENT AND STORM PIPING SHALL BE SERVICE WEIGHT CAST IRON, NO-HUB WITH STAINLESS STEEL CLAMPS AND SHIELDS WITH NEOPRENE SEALING SLEEVES.

46. ALL SOIL AND WASTE PIPING, 2-1/2" AND SMALLER, SHALL BE SLOPED AT 1/4" PER FOOT. LARGER WASTE PIPING SHALL BE SLOPED AT 1/8" PER FOOT.

47. TEST SANITARY WASTE, VENT AND STORM PIPING BY A 10' WATER COLUMN FOR TWENTY-FOUR 13. CONTRACTOR SHALL EXTEND AS NECESSARY AND CONNECT BUILDING DRAIN AND POTABLE WATER (24) HOURS OR AS REQUIRED BY THE BUILDING DEPARTMENT.

> 48. INSULATE INTERIOR ABOVEGROUND STORM WATER PIPING, ALL HORIZONTAL AND ALL IN CONDITIONED SPACE WITH 1-INCH THICK FIBERGLASS INSULATION FINISHED WITH WHITE MASTIC OR

49. ROOF SUMPS: INSULATE WITH 1-INCH THICK RIGID FIBERGLASS BOARD.

50. INSULATION FIT: INSULATION SHALL BE APPLIED TO PIPE AND EQUIPMENT WITH ALL JOINTS FITTED TO ELIMINATE VOIDS. VOIDS SHALL NOT BE FILLED WITH JOINT SEALANT, BUT SHALL BE

ELIMINATED BY REFITTING OR REPLACING INSULATION. 51. ALL VENTS THROUGH ROOF SHALL BE A MINIMUM OF 10'-0" OR AS REQUIRED BY CODE AWAY FROM

52. ALL VENTS THROUGH ROOF SHALL BE PROVIDED WITH FOUR (4) POUND SHEET LEAD FLASHING EXTENDING UPWARD AROUND THE PIPE AND TURNED DOWN INSIDE THE PIPE.

53. SHALL BE INSTALLED IN ACCORDANCE WITH THE 2020, 7th EDITION FLORIDA BUILDING CODE OR NFPA-54 WHERE REQUIREMENTS ARE MORE STRINGENT.

54. PIPE SIZE 2-INCH AND SMALLER: BLACK STEEL PIPE; SCHEDULE 40; MALLEABLE-IRON THREAD

55. PIPE SIZE 2-1/2 INCH AND LARGER: BLACK STEEL PIPE, SCHEDULE 40, WROUGHT- STEEL BUTT WELDED FITTINGS.

56. ALL GAS EQUIPMENT SHALL BE AGA APPROVED.

57. THE INSTALLATION SHALL BE FOR NATURAL GAS.

58. THE INSTALLING SUBCONTRACTOR SHALL BE LICENSED FOR THE INSTALLATION OF NATURAL GAS.

59. THE INSTALLATION SHALL BE FOR PROPANE GAS.

60. THE INSTALLING SUBCONTRACTOR SHALL BE LICENSED FOR THE INSTALLATION OF PROPANE GAS. 61. ANY GAS PIPING, WHICH IS EXPOSED TO BUILDING EXTERIOR OR OTHER CORROSIVE ENVIRONMENTS, SHALL BE GALVANIZED STEEL PIPE: SCHEDULE 40; GALVANIZED MALLEABLE-IRON THREADED FITTINGS.

62. GAS PIPING SHALL BE HUNG TIGHT TO THE ROOF STRUCTURE, SUPPORTED WITH HANGERS BY GRINNELL OR EQUAL.

63. BRANCH TAPS MUST BE MADE OFF OF THE TOP OF THE PIPING.

64. CONNECTION TO EACH PIECE OF EQUIPMENT SHALL INCLUDE AN INVERTED TRAP, A GAS COCK, A UNION AND A DIRT LEG. CONNECTIONS SHALL BE RIGID (NO FLEX).

65. ALL GAS FLUES SHALL BE A MINIMUM OF 10'-0", OR AS REQUIRED BY CODE, AWAY FROM FRESH AIR

MISCELLANEOUS

66. THE POOL SUPPLIER SHALL ONLY USE CARTRIDGE FILTERS. BACKWASH TYPE FILTERS ARE NOT

67. POOL WATER SHALL BE DECHLORINATED PRIOR TO DISCHARGE INTO THE MAIN POOL DRAIN. CONTRACT THE LOCAL POOL SUPPLY COMPANY FOR MEANS AND METHODS OF THE DECHLORINATION

68. PROVIDE AND INSTALL SHUT OFF VALVES AND SECTIONAL VALVES AS REQUIRED BY APPLICABLE FLORIDA BUILDING CODES AND PLUMBING SPECIFICATION SECTIONS.

69. PIPE ROUTING IS SHOWN DIAGRAMMATICALLY AND DOES NOT SHOW ALL OFFSETS, DROPS, AND RISES OF RUNS. THE CONTRACTOR SHALL ALLOW IN HIS PRICE FOR ROUTING OF PIPE TO AVOID OBSTRUCTIONS. COORDINATION WITH UTILITY SERVICES, INCLUDING THOSE OF OTHER TRADES IS REQUIRED. MAINTAIN HEADROOM AND SPACE LOCATIONS.

70. INSTALL WORK AS TO BE READILY ACCESSIBLE FOR OPERATION, MAINTENANCE, AND REPAIR. MINOR DEVIATIONS FROM DRAWINGS MAY BE MADE TO ACCOMPLISH THIS, BUT CHANGES WHICH INVOLVE EXTRA COST SHALL NOT BE MADE WITHOUT APPROVAL.

71. ALL MATERIALS AND EQUIPMENT TO BE NEW UNLESS OTHERWISE NOTED AND SHALL BE IN ACCORDANCE WITH BUILDING STANDARDS. ALL MATERIALS AND EQUIPMENT ON SITE SHALL BE PROPERLY STORED SUCH THAT IT IS PROTECTED FROM DAMAGE AND EXPOSURE.

72. THE FINAL ACCEPTANCE WILL BE MADE AFTER THE CONTRACTOR HAS ADJUSTED HIS EQUIPMENT, TESTED THE VARIOUS SYSTEMS, DEMONSTRATED THAT IT FULFILLS THE REQUIREMENTS OF THE DRAWINGS AND SPECIFICATIONS, HAS FURNISHED ALL THE REQUIRED CERTIFICATIONS OF INSPECTION AND APPROVAL, AND SUBMITTED ALL THE NECESSARY CLOSE-OUT DOCUMENTS.

73. UPON COMPLETION AND ACCEPTANCE OF WORK, CONTRACTOR SHALL FURNISH WRITTEN INSTRUCTIONS AND EQUIPMENT MANUALS AND DEMONSTRATE TO THE OWNER THE PROPER OPERATION AND MAINTENANCE OF ALL EOUIPMENT AND APPARATUS FURNISHED UNDER THIS CONTRACT. THESE INSTRUCTIONS SHALL BE TYPED ON 8-1/2 IN. X 11 IN. PAPER AND BOUND IN THREE RING BINDERS WITH CLEAR ACETATE COVERS. CONTRACTOR SHALL GIVE THREE COPIES OF THE INSTRUCTIONS TO THE OWNER AND ONE COPY TO THE ENGINEER. THE INSTRUCTION BOOKLET SHALL BEAR THE NAME, ADDRESS, AND TELEPHONE NUMBER OF THE GENERAL CONTRACTOR, PLUMBING CONTRACTOR, ARCHITECT, AND ENGINEER. REPRODUCIBLE "AS-BUILT" DRAWINGS SHALL BE PROVIDED INDICATING THE AS INSTALLED CONDITIONS OF THE WORK. "AS-BUILT" DRAWINGS SHALL BE PROVIDED TO THE ARCHITECT AFTER COMPLETION OF THE INSTALLATION.

74. ALL VALVES AND SPECIALTY ITEMS MAY NOT BE SHOWN IN EVERY INSTANCE ON THE DRAWINGS, BUT ARE TO BE PROVIDED WHETHER SHOWN OR NOT WHEN NECESSARY FOR PROPER OPERATION AND MAINTENANCE OF THE SYSTEM.

UNLESS OTHERWISE NOTED, VALVES AND SPECIALTY ITEMS ARE TO BE RATED AT 125 PSIG. DEVICES AND VALVES 2-1/2" AND SMALLER ARE TO HAVE SOLDERED OR SCREWED CONNECTION AND 3" AND LARGER ARE TO HAVE FLANGED CONNECTIONS.

REFER TO SPECIFICATIONS FOR APPROVED VALVE MANUFACTURERS.

75. CONCEAL ALL PIPING IN BUILDING CONSTRUCTION OR UNDERGROUND. INSTALL SUCH PIPING IN TIME SO AS NOT TO CAUSE DELAY TO WORK OF OTHER TRADES AND TO ALLOW AMPLE TIME FOR TESTS AND APPROVAL; DO NOT COVER BEFORE APPROVAL IS OBTAINED.

76. KEEP FIXTURE BRANCHES CONCEALED TO POINTS ABOVE FLOOR CLOSE TO FIXTURES; EXPOSE ONLY AS MUCH AS NECESSARY FOR FINAL CONNECTIONS.

77. WHERE FURRED SPACES ARE INDICATED, KEEP PIPES AS CLOSE TO STRUCTURAL MEMBERS AS POSSIBLE SO AS TO REQUIRE MINIMUM FURRINGS.

78. THE PLUMBING CONTRACTOR SHALL PROVIDE ESCUTCHEONS AT EACH POINT WHERE AN WILL NOT GENERALLY BE REQUIRED FOR INSULATED PIPE AND CONDUIT OR TUBING PASSING THROUGH EQUIPMENT ROOM WALLS UNLESS, IN THE OPINION OF THE ENGINEER, THE INSTALLATION OF SUCH PIPE, CONDUIT, OR TUBING HAS NOT BEEN INSTALLED IN A NEAT AND ACCEPTABLE. ESCUTCHEONS SHALL BE CONSTRUCTED OF CHROME -PLATED BRASS UNLESS SPECIFICALLY APPROVED OTHERWISE BY THE ARCHITECT. EACH ESCUTCHEON SHALL FIT FLUSH WITH THE WALL OR FLOOR AND SHALL FIT SNUGLY AROUND THE PIPE.



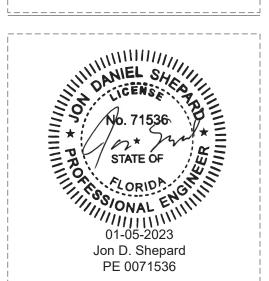
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